
MULTIFAMILY HOUSING 1 ENTITLEMENT SUBMITTAL

BROOKLYN CENTER
ALATUS LLC



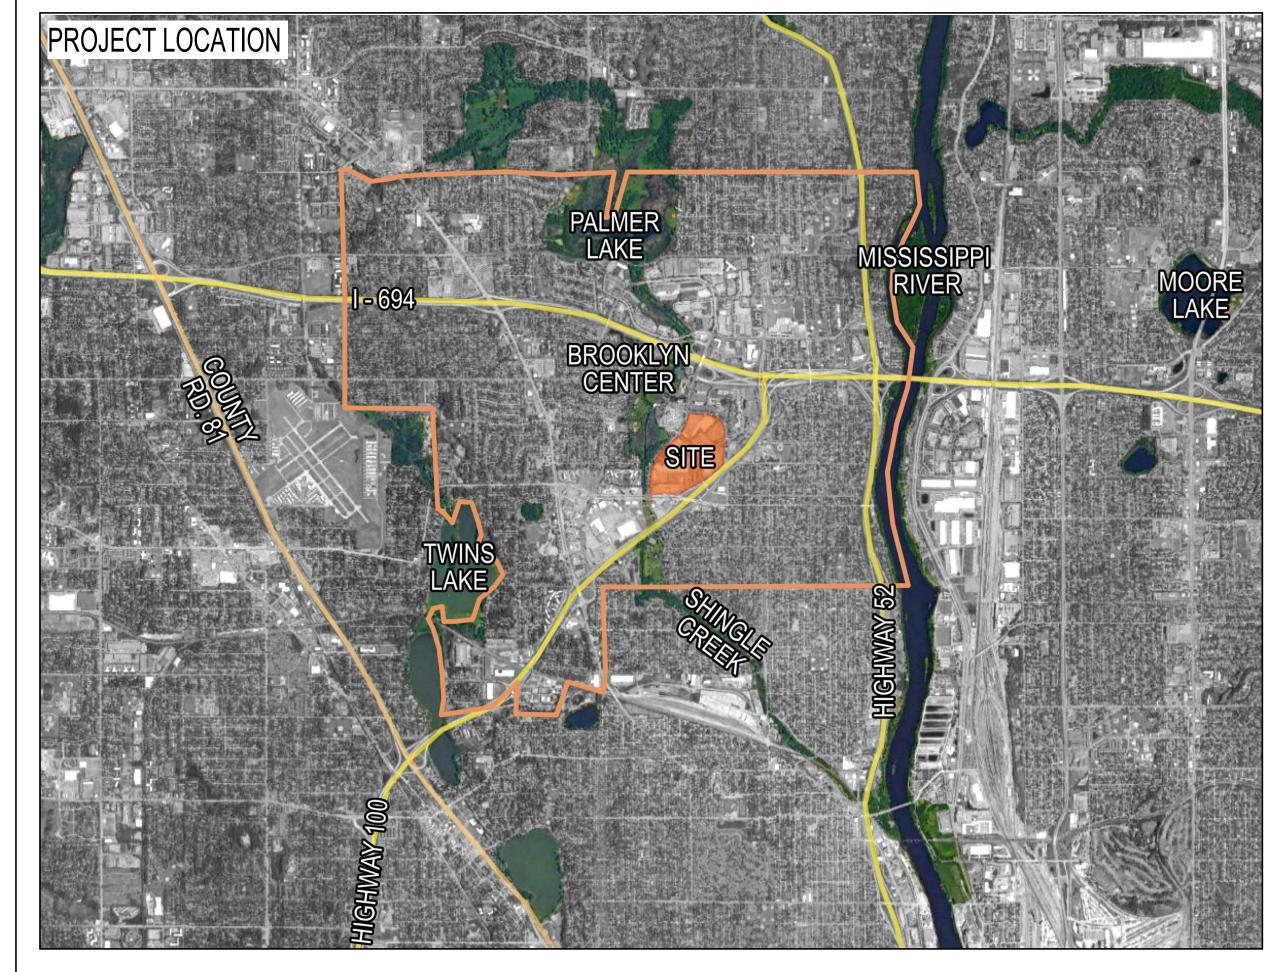

OWNER / APPLICANT: Alatus, LLC

800 Nicollet Mall, Suite 2850 Minneapolis, MN 55402 Phone: 612.455.0700 Contact: Chris Osmundson

Boarman Kroos Vogel Group, Inc

222 North Second Street
Minneapolis, Minnesota 55401

Pierce Pini + Associates, Inc.

9298 Central Avenue NE Suite 312

Boarman Kroos Vogel Group, Inc

Minneapolis, Minnesota 55401

222 North Second Street

Phone: 612.339.3752

Fax: 612.339.6212 Contact: Brady Halverson

Mechanical Engineering:

222 North Second Street

Phone: 612.339.3752

Fax: 612.339.6212

Contact: Alex Sawka

Boarman Kroos Vogel Group, Inc

Minneapolis, Minnesota 55401

Boarman Kroos Vogel Group, Inc

222 North Second Street Minneapolis, Minnesota 55401

Phone: 612.339.3752 Fax: 612.339.6212 Contact: Chad Kurdi

Structural Engineering:

Phone: 612.339.3752

Fax: 612.339.6212

Contact: Kyle Olson

Boarman Kroos Vogel Group, Inc


222 North Second Street Minneapolis, Minnesota 55401

Phone: 612.339.3752 Fax: 612.339.6212 Contact: Mike Krych

Blaine, MN, 55434 Phone: 763.537.1311 Contact: Rhonda Pierce

Architect:

		MULTI FAMILY 1 SHEET INDEX
Discipline	Sheet Number	Sheet Name
00 - GENERAL	G100	ALATUS - MULTIFAMILY HOUSING 1 - COVER SHEET
00 - GENERAL	G101	ALATUS - MULTIFAMILY HOUSING 1 - PARKING EXHIBIT
01 - CIVIL	C100	GENERAL NOTES AND LEGEND
01 - CIVIL	C120	SITE DEMOLITION PLAN
01 - CIVIL	C130	SWPPP NARRATIVE
01 - CIVIL	C131	SWPPP SITE LAYOUT PLAN
01 - CIVIL	C132	SWPPP DETAILS
01 - CIVIL	C140	GRADING AND DRAINAGE PLAN
01 - CIVIL	C150	UTILITY PLAN
01 - CIVIL	C160	SITE LAYOUT AND PAVING PLAN
01 - CIVIL	C170	CIVIL DETAILS
01 - CIVIL	C171	CIVIL DETAILS
02 - LANDSCAPE	L100	ALATUS - MULTIFAMILY HOUSING 1 - LANDSCAPE PLAN
03 - ARCHITECTURE	A100	ALATUS - MULTIFAMILY HOUSING 1 - SITE
03 - ARCHITECTURE	A101	ALATUS - MULTIFAMILY HOUSING 1 - LEVEL 1
03 - ARCHITECTURE	A101.5	ALATUS - MULTIFAMILY HOUSING 1 - LEVEL 1.5
03 - ARCHITECTURE	A102	ALATUS - MULTIFAMILY HOUSING 1 - LEVEL 2
03 - ARCHITECTURE	A103	ALATUS - MULTIFAMILY HOUSING 1 - LEVEL 3
03 - ARCHITECTURE	A104	ALATUS - MULTIFAMILY HOUSING 1 - LEVEL 4
03 - ARCHITECTURE	A105	ALATUS - MULTIFAMILY HOUSING 1 - LEVEL 5
03 - ARCHITECTURE	A106	ALATUS - MULTIFAMILY HOUSING 1 - LEVEL 6
03 - ARCHITECTURE	A107	ALATUS - MULTIFAMILY HOUSING 1 - EXTERIOR ELEVATIONS
03 - ARCHITECTURE	A108	ALATUS - MULTIFAMILY HOUSING 1 - COURTYARD ELEVATIONS
03 - ARCHITECTURE	A109	ALATUS - MULTIFAMILY HOUSING 1 - RENDERINGS

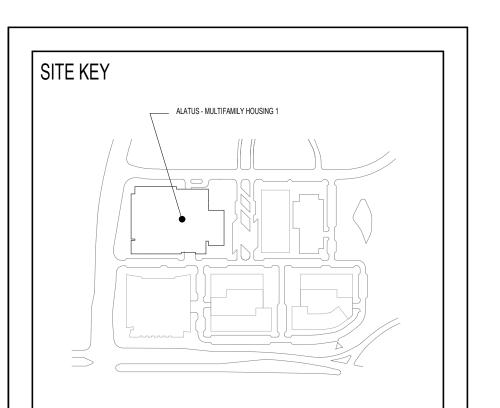

BIM 360://2344-(

Lev	vel Studio	Alcove	1A	1B	2A	2B	3A	4A	Total	Amenities & Suppo	ort							Tabulations			
	310010	Alcove	TA .	ID	2A	26	- SA	44	loidi	lobby/	Club / Co-workin	ng Incubator Space	Shared Fitness	MEP & Services	Loading& Trash	Parking Area	Parking	Gross Building Area (Does			Efficiency
		4								Lounge	CIODY CO WOMEN						Count	not include incubator)	GRSF	NRSF	(NRSF / (GROSS BLDG = PARKING - FITNESS)
1	_	2 1	7	2	2	4	1	2	21	3,060		10,006	2,279	2,244	985	56,984	140	87,234	21,682	16,877	60.34%
P1.													1,572			94,402	156	56,542			
2	2	4 6	10	2	2	6	2	2	34	2,854	3,743	10,006	2,788		443	34,943	99	74,773	30,002	23,071	32.05%
3	_	4 17	20	2	0	9	3	2	67					223	194			68,458	68,041	62,328	91.05%
4	_	4 17	19	3	1	8	3	2	67					184	194			54,493	54,115	48,218	88.48%
5		2 14	15	3	0	6	3	1	54					163	194			43,186	42,829	37,976	87.94%
6		8 9	11	1	0	5	1	0	35		1,850			148	95			29,473	27,380	25,050	84.99%
ег Туре		E4 /4	90	10	-	20	10	0	278	5,914	5,593	20,012	6,639	2,962	2,105	186,329	395	414,159	244,049	213,520	93.72%
io(Per Unit)	1.0	00 1.00	1.00	1.00	1.00	1.00	1.00	1.00	2/0	5,914	3,393		6,637	2,762	2,105			414,139	244,049	213,520	73.72%
quired(Stalls)	1.3	54 (4	82	1.00	1.00	1.00	1.00	1.00	278			(5 Per 1,000 SF)			-		Area/space Parking Ratio	1			
g Provided		4 04	02	13		30	13	7	395						L		(Per Unit)	J			
Unit Count		54 64	82	13	5	38	13	9	278									144,536	Site Area	3.	32 Acres
		54 64	82	13	10	76	39	36	374									83.8	Density	=	Total units / Acreage
oe e									213,520									0.60	Lot Coverage	=	Ground Floor/Site Area
Market Rate Unit									768									227,830	GFA	=	Gross Bldg Area - Parking Are
	4	54 64	82	13	5	38	13	9	278									1.58	FAR	=	GFA / Site Area
t ype Market Rate Unit		4 64 54 64	82	13	5	76	13	36 9	213,520 768									0.60 227,830	Lot Coverage GFA	=	Ground Floor/Site / Gross Bldg Area - F

B K V
G R O U P

Architecture
Interior Design
Landscape Architecture
Engineering

222 North Second Street

Long & Kees Bldg Suite 101 Minneapolis, MN 55401 612.339.3752

www.bkvgroup.com

CONSULTANTS

PIERCE PINI &

ASSOCIATES

9298 CENTRAL AVENUE NE,
SUITE 312
BLAINE, MN 55434
TEL 763.537.1311

PROJECT TITLE

BROOKLYN CENTER -ALATUS -MULTIFAMILY HOUSING 1

ISSUE # DATE DESCRIPTION

1 05/10/2022 LAND USE APPLICATION

2 06/14/2022 LAND USE APPLICATION

CONSTRUCTION

DRAWN BY Author
CHECKED BY Checker
COMMISSION NUMBER 2344.03
SHEET TITLE


ALATUS MULTIFAMILY
HOUSING 1 COVER SHEET

SHEET NUMBER


G100

PUBLIC PARKWAY

Туре	Level	Coun
ALATUS - MULTIFAMILY 1 - ACCESSIBLE	LEVEL 1	8
ALATUS - MULTIFAMILY 1 - COMPACT	LEVEL 1	28
ALATUS - MULTIFAMILY 1 - STANDARD	LEVEL 1	104
LEVEL 1: 140		
ALATUS - MULTIFAMILY 1 - COMPACT	LEVEL 1.5	35
ALATUS - MULTIFAMILY 1 - STANDARD	LEVEL 1.5	121
LEVEL 1.5: 156	•	
ALATUS - MULTIFAMILY 1 - COMPACT	LEVEL 2	22
ALATUS - MULTIFAMILY 1 - STANDARD	LEVEL 2	77

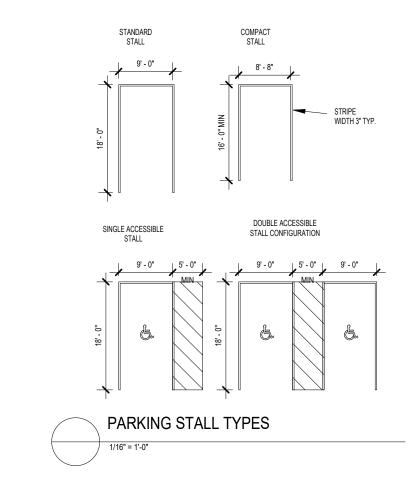



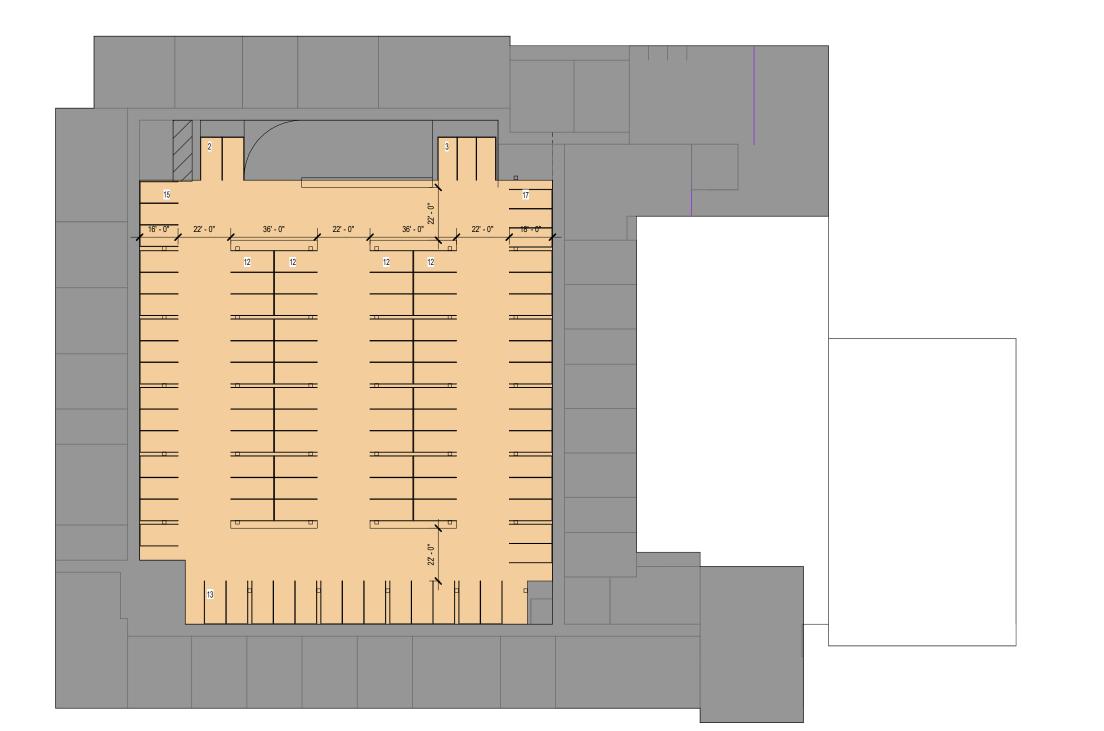

LEVEL 2 - ALATUS - MULTIFAMILY HOUSING 1 - PARKING

1" = 40'-0"

Architecture Interior Design Landscape Architecture Engineering

222 North Second Street Long & Kees Bldg Suite 101 Minneapolis, MN 612.339.3752

www.bkvgroup.com

CONSULTANTS

PIERCE PINI & ASSOCIATES
9298 CENTRAL AVENUE NE,
SUITE 312
BLAINE, MN 55434
TEL 763.537.1311

PROJECT TITLE

BROOKLYN CENTER -ALATUS -MULTIFAMILY HOUSING 1

ISSUE # DATE DESCRIPTION

1 05/10/2022 LAND USE APPLICATION

2 06/14/2022 LAND USE APPLICATION

SHEET TITLE

ALATUS -MULTIFAMILY HOUSING 1 -PARKING EXHIBIT

SHEET NUMBER

NOTES

- 1. ALL EXISTING INFORMATION TAKEN FROM SURVEY PROVIDED BY BOLTON & MENK DATED MARCH 4, 2022.
- 2. SUBSURFACE GEOTECHNICAL INVESTIGATION BY BRAUN INTERTEC IS UNDERWAY.
- 3. CONTRACTOR TO FIELD VERIFY ALL EXISTING CONDITIONS INCLUDING LOCATIONS OF EXISTING UTILITIES, AND NOTIFY ENGINEER OF ANY DISCREPANCIES PRIOR TO STARTING
- CONSTRUCTION. 4. ALL AREAS DISTURBED BY CONSTRUCTION WHICH ARE OUTSIDE THE LIMITS OF PAVING ARE TO BE RESTORED AND REVEGETATED.
- 5. ALL UTILITY DEMOLITION AND/OR ABANDONMENT TO BE PERFORMED IN ACCORDANCE WITH THE CITY OF BROOKLYN CENTER AND STATE OF MINNESOTA REGULATIONS AND STANDARDS.
- 6. EXISTING UTILITIES ARE SHOWN IN THEIR APPROXIMATE LOCATIONS. CONTRACTOR TO FIELD VERIFY THE LOCATION OF ALL EXISTING UTILITIES WHICH MAY INCLUDE BUT IS NOT LIMITED TO: ELECTRIC, TELEPHONE, GAS, CABLE TV COMPUTER CABLE, FIBER OPTIC CABLE, SANITARY SEWER, STORM SEWER, STEAM, CONDENSATE, ELECTRICAL DUCTBANK AND WATERMAIN. CONTRACTOR TO CONTACT GOPHER ONE-CALL BEFORE EXCAVATING.
- 7. ALL EXISTING UTILITIES AND OTHER IMPROVEMENTS ARE TO REMAIN UNLESS NOTED OTHERWISE.

CONTRACTOR.

- 8. CONTRACTOR TO PROTECT FROM DAMAGE ALL EXISTING IMPROVEMENTS, LANDSCAPING, STRUCTURES AND UTILITIES THAT ARE TO REMAIN. CONTRACTOR TO REPAIR ANY DAMAGE AT OWN EXPENSE.
- 9. ALL WORK TO CONFORM WITH CITY OF BROOKLYN CENTER AND STATE OF MINNESOTA STANDARDS AND REGULATIONS
- 10. ALL EXCAVATIONS MUST COMPLY WITH THE REQUIREMENTS OF OSHA 29 CFR, PART 1926, SUBPART P "EXCAVATIONS AND TRENCHES". THIS DOCUMENT STATES THAT EXCAVATION SAFETY IS THE SOLE RESPONSIBILITY OF THE
- 11. PROVIDE BARRICADES AT STREETS AND SIDEWALKS PER CITY OF BROOKLYN CENTER AND MINNESOTA MANUAL ON UNIFORM TRAFFIC CONTROL DEVICES (MN MUTCD).
- 12. CONTRACTOR SHALL OBTAIN ALL REQUIRED PERMITS PRIOR
- TO STARTING CONSTRUCTION. 13. ALL MATERIALS FOR PROPOSED CONSTRUCTION OR REPAIR OF EXISTING FACILITIES SHALL BE NEW PRODUCTS DIRECT
- FROM THE FACTORY AND FREE FROM DEFECTS. 14. WHEN WORKING AROUND EXISTING TELEPHONE OR ELECTRICAL POLES, THE CONTRACTOR SHALL BRACE THE POLE FOR SUPPORT.
- 15. WHEN WORKING AROUND EXISTING UTILITIES THAT BECOME EXPOSED, THE CONTRACTOR SHALL PROVIDE SUFFICIENT SUPPORT TO PREVENT EXCESSIVE STRESS ON THE PIPING. THE CONTRACTOR IS FULLY RESPONSIBLE FOR ANY DAMAGES CAUSED BY FAILURE TO EXACTLY LOCATE AND PRESERVE THESE UNDERGROUND FACILITIES.
- 16. CONTRACTOR TO FIELD VERIFY THE EXACT LOCATION AND ELEVATION OF EXISTING STORM AND SANITARY SEWER PRIOR TO THE START OF CONSTRUCTION, IF ELEVATIONS DIFFER FROM SURVEYED ELEVATIONS SHOW ON PLAN, REPORT DISCREPANCIES TO ENGINEER PRIOR TO CONSTRUCTION.
- 17. SITE UTILITY CONTRACTOR TO FURNISH AND INSTALL ALL WATERMAIN, SANITARY SEWER AND STORM SEWER FACILITIES AND APPURTENANCES TO WITHIN FIVE FEET OUTSIDE THE BUILDING. COORDINATE WITH MECHANICAL CONTRACTOR FOR EXACT LOCATION AND DEPTH OF CONNECTION WITHIN BUILDING.
- 18. CATCH BASINS AND MANHOLES ARE SHOWN ON PLAN LARGER THAN ACTUAL SIZE. COORDINATE LOCATION OF MANHOLE COVER AND CASTING SO THAT IT IS PROPERLY LOCATED AT THE BACK OF CURBLINE FOR THE CURB INLETS OR CENTERED IN THE AREA AS SHOWN ON THE PLAN FOR THE AREA DRAINS AND MANHOLE COVERS.
- 19. CONTRACTOR SHALL COORDINATE WITH ARCHITECT'S DRAWINGS TO VERIFY LOCATION, SIZE AND QUANTITY OF ALL ROOF DRAINS AND UTILITY CONNECTIONS. LIMITS OF PROPOSED SITE PLUMBING FACILITIES SHALL BE FIVE FEET FROM EDGE OF BUILDING UNLESS OTHERWISE NOTED.
- 20. PROVIDE THE FOLLOWING MINIMUM COVER OVER THE TOP OF PIPE AS FOLLOWS:
- A. 8' OVER WATERMAIN
- B. 5' OVER SANITARY SEWER C. 2' OVER STORM SEWER
- 21. ALL WATERMAIN AND SERVICES TO BE INSTALLED IN ACCORDANCE WITH CITY OF BROOKLYN CENTER WATER STANDARDS. ALL WATER MAIN AND SERVICES TO BE INSTALLED IN ACCORDANCE WITH RECOMMENDED STANDARDS FOR WATER WORKS BY THE GREAT LAKES UPPER MISSISSIPPI RIVER BOARD OF STATE PUBLIC HEALTH AND ENVIRONMENTAL MANAGERS (TEN-STATE STANDARDS) AND STATE OF MINNESOTA PLUMBING CODE,
- 22. ALL PAVEMENT MARKINGS WITHIN EXISTING CITY PAVEMENT AREAS TO BE RESTORED TO MATCH EXISTING UNLESS NOTED OTHERWISE.
- 23. MAXIMUM CROSS-SLOPES FOR SIDEWALKS AND ADA ACCESS ROUTES SHALL NOT EXCEED 2.00%. MAXIMUM SLOPES FOR ADA PARKING STALLS AND ADA ACCESS AISLES SHALL NOT EXCEED 2.00% IN ANY DIRECTION. MAXIMUM RUNNING SLOPE FOR ALL SIDEWALKS SHALL NOT EXCEED 5.00%.
- 24. THE CONTRACTOR SHALL PROVIDE A CONTINUOUS, ACCESSIBLE AND SAFE PEDESTRIAN WALKWAY THAT MEETS ADA AND MINNESOTA MUTCD STANDARDS IF WORKING IN A SIDEWALK AREA, AND TRAFFIC CONTROL PER MINNESOTA MUTCD REQUIREMENTS FOR WORK IN THE PUBLIC RIGHT-OF-WAY.
- 25. WASTE MATERIALS INCLUDING PAVEMENT REMOVED DURING CONSTRUCTION, WASTE PIPING AND SUPPLIES, CONSTRUCTION DEBRIS AND EXCESS EXCAVATED MATERIAL SHALL BECOME THE PROPERTY OF THE CONTRACTOR AND SHALL BE REMOVED FROM THE PROJECT SITE AND DISPOSED OF PROPERLY BY THE CONTRACTOR.
- 26. CONTRACTOR SHALL NOT BLOCK DRAINAGE FROM OR DIRECT EXCESS DRAINAGE ONTO ADJACENT PROPERTY.
- 27. ADEQUATE DRAINAGE SHALL BE MAINTAINED AT ALL TIMES DURING CONSTRUCTION AND ANY EXISTING DRAINAGE DITCH OR STRUCTURE DISTURBED DURING CONSTRUCTION SHALL BE RESTORED TO THE SATISFACTION OF THE OWNING AUTHORITY. ALL CONSTRUCTION STORM RUNOFF SHALL COMPLY WITH THE NATIONAL POLLUTANT DISCHARGE 53. WITHIN LANDSCAPE AREAS ALL CLASS V MATERIAL SHALL ELIMINATION SYSTEM (NPDES) REQUIREMENTS.
- 28. CARE MUST BE TAKEN DURING CONSTRUCTION AND EXCAVATION TO PROTECT ANY SURVEY MONUMENTS

AND/OR PROPERTY IRONS.

- 29. COORDINATE SCHEDULING OF CLOSURES AND RE-OPENINGS OF EGRESSES, LOADING DOCKS, DUMPSTERS, DRIVEWAYS, SIDEWALKS AND ROADS WITH WNER AND CITY OF BROOKLYN CENTER. TRAFFIC CONTROL SIGNAGE, TEMPORARY WALKWAYS AND TEMPORARY DRIVEWAYS TO CONFORM WITH CITY OF BROOKLYN CENTER AND STATE OF MINNESOTA REQUIREMENTS AND STANDARDS.
- 30. DRAWINGS DO NOT INDICATE AREAS OF TEMPORARY SUPPORT SYSTEMS. THE CONTRACTOR IS RESPONSIBLE FOR ALL MEANS AND METHODS AND WILL HAVE TOTAL CONTROL OVER THE TYPES AND DESIGN OF ALL SHORING, SHEETING, BRACING, ANCHORAGES, EXCAVATION SUPPORT WALLS, DIRECTIONAL BORING, AUGER JACKING, SOIL STABILIZATION AND OTHER METHODS OF PROTECTING EXISTING IMPROVEMENTS. SEE SPECIFICATIONS FOR SUBMITTAL REQUIREMENTS.
- 31. STORAGE AND PROTECTION OF EXISTING SITE FEATURES WHICH NEED TO BE REMOVED AND REPLACED FOR CONSTRUCTION OF PROJECT ARE THE RESPONSIBILITY OF THE CONTRACTOR. STORAGE SHALL BE WITHIN THE LIMITS OF STAGING AREA. CONTRACTOR SHALL PREVENT DAMAGE OR THEFT OF THESE ITEMS AND TO REPLACE AT OWN EXPENSE.

- 32. CONTRACTOR TO RECORD EXISTING CONDITIONS (PHOTOGRAPHS, VIDEO PHOTOGRAPHY, FIELD SURVEYING, ETC.) TO ENABLE RECONSTRUCTION TO MATCH EXISTING CONDITIONS AS REQUIRED. CONTRACTOR TO DOCUMENT EXISTING CONDITIONS SO THAT RECONSTRUCTED AREAS WILL HAVE POSITIVE DRAINAGE SIMILAR TO EXISTING.
- 33. WHERE DEMOLITION, EXCAVATION, UNDERPINNING, PILE DRIVING, COMPACTING OR SIMILAR WORK IS TO BE PERFORMED ADJACENT TO OR IN THE IMMEDIATE VICINITY OF EXISTING STRUCTURES, THE CONTRACTOR WILL PROVIDE BUILDING SURVEYS AND SEISMIC MONITORING. 34. ALL EXISTING BUILDING EXITS AND DRIVEWAYS SHALL
- REMAIN UNOBSTRUCTED AND USABLE AT ALL TIMES. IF THERE ARE UNAVOIDABLE EXCEPTIONS, THEN CONTRACTOR SHALL PROVIDE TEMPORARY EXIT PLANS TO THE OWNER FOR APPROVAL PRIOR TO CONSTRUCTION. 35. SANITARY SEWER PIPE AND FITTINGS TO BE POLYVINYL
- CHLORIDE (PVC), SDR 26 MINIMUM AND COMPLY WITH ASTM D3034 AND F679. JOINTS TO BE SOLVENT CEMENT OR FLEXIBLE WATERTIGHT.
- 36. STORM SEWER PIPE TO BE REINFORCED CONCRETE PIPE (RCP), ASTM C76, CLASS 5, WITH GASKETED JOINTS OR POLYVINYL CHLORIDE (PVC) SDR 26 MINIMUM COMPLYING WITH ASTM D3034 AND F679 WITH SOLVENT CEMENT OR FLEXIBLE WATERTIGHT JOINTS OR HDPE WITH FLEXIBLE WATERTIGHT JOINTS, PER SPECIFICATIONS AS NOTED ON
- 37. WATERMAIN TO BE DUCTILE IRON PIPE (DIP) THICKNESS CLASS 52 FOR 8" DIP AND THICKNESS CLASS 53 FOR 4" AND 6" DIP, ANSI A-21.51, 150 PSI WORKING PRESSURE MINIMUM. TYPE K COPPER SHALL BE USED FOR PIPES LESS THAN 4" DIAMETER.
- 38. MAINTAIN 10 FEET HORIZONTAL AND 3 FEET VERTICAL SEPARATION BETWEEN WATER AND SEWER PIPES. IF INFEASIBLE A 12-INCH VERTICAL SEPARATION WITH 4-INCH HIGH DENSITY INSULATION BETWEEN PIPES WILL BE REQUIRED.
- 39. WHERE PRACTICABLE INSTALL WATERMAIN GATE VALVES WITHIN GREEN SPACE AREAS TWO FEET OFFSET FROM THE MAIN. SIDEWALKS SHALL BE STAKED AND EXACT LOCATIONS OF WATER VALVES COORDINATED IN THE FIELD, TYPICAL FOR ALL.
- 40. SEQUENCING OF UTILITIES AND STRUCTURAL SYSTEMS SHALL BE CAREFULLY COORDINATED. CONTRACTOR SHALL ALSO TAKE CARE TO PROTECT SERVICE CONNECTIONS AND ADJACENT PARALLEL UTILITY LINES WHILE FORMING AND PLACING CONCRETE FOR OTHER HEAVY CONSTRUCTION WITHIN THE AREA. CONTRACTIBILITY OF THE STRUCTURAL SYSTEMS SHALL TAKE INTO ACCOUNT ANY UTILITY WORK SO PIPE/CONDUIT OR STRUCTURES ARE NOT DISPLACED, CRUSHED, OR OTHERWISE ADVERSELY AFFECTED DURING CONSTRUCTION.
- 41. ALL STUMPS FROM TREES REMOVED WITHIN PROJECT LIMITS SHALL BE GROUND AND REMOVED IN THEIR ENTIRETY.
- 42. CONTRACTOR IS RESPONSIBLE FOR PROPER REMOVAL AND DISPOSAL OF ALL DEBRIS, EXCESS FILL AND OTHER UNUSED MATERIALS GENERATED BY PROJECT AND DONE IN FULL COMPLIANCE WITH ALL LOCAL, STATE AND FEDERAL RULES AND REGULATIONS. THE SITE SHALL BE KEPT CLEAN AND FREE FROM ALL WASTE MATERIALS.
- 43. ALL WORK WILL BE IN ACCORDANCE WITH OSHA CODES AND STANDARDS. NOTHING INDICATED ON THE DRAWINGS OR SPECIFICATIONS SHALL RELIEVE THE CONTRACTOR FROM COMPLYING WITH ANY APPROPRIATE SAFETY REGULATIONS.
- 44. PROVIDE AN EXPANSION JOINT AROUND ALL EXISTING UTILITIES, MANHOLES, POLES, LIGHTS, POSTS, BOXES, ETC. WITHIN AREAS OF NEW OR RECONSTRUCTED CONCRETE
- 45. ALL EXPOSED CONCRETE (CURB, STEPS, WALLS, ETC.) TO HAVE A CONSISTENT RUBBED FINISH. CONTRACTOR TO PROVIDE MINIMUM FOUR SQUARE FOOT MOCK-UP FOR
- PAVEMENT TYPES FOR REVIEW AND APPROVAL. ALL CONCRETE SIDEWALKS TO HAVE BROOM FINISH. MOCK-UP TO REMAIN ON SITE THROUGHOUT CONSTRUCTION. 47. THICKENED EDGE EXPANSION JOINTS SHALL BE PLACE

46. CONTRACTOR TO PROVIDE MINIMUM 4'X4' OF ALL

REVIEW AND APPROVAL

- ALONG THE EDGE OF ALL CONCRETE PAVEMENT AT THE PERIMETER OF ALL STRUCTURES, CONCRETE CURB AND GUTTER ADJACENT PAVEMENT. 48. THE DRAWINGS REPRESENT TO FINISHED SITE NOT THE
- METHOD OF CONSTRUCTION. THE ENGINEER IS NOT RESPONSIBLE FOR CONTRACTOR'S MEANS AND METHODS, SEQUENCING OF CONSTRUCTION OR SAFETY PROGRAM. OBSERVATION VISITS TO THE SITE BY THE ENGINEER WILL NOT INVOLVE REVIEW OF THESE ITEMS.
- 49. WHERE DISCREPANCIES OCCUR BETWEEN GENERAL NOTES, PLANS, DETAILS AND SPECIFICATIONS, THE MOST STRINGENT REQUIREMENTS SHALL GOVERN, UNLESS OTHERWISE VERIFIED BY THE ENGINEER OR ARCHITECT IN
- 50. THESE DOCUMENTS SHALL NOT BE CONSTRUED AS STAND-ALONE DOCUMENTS. CONTRACTOR SHALL COORDINATE WITH ALL OTHER DISCIPLINE'S DOCUMENTS.
- 51. FOR TREES TO REMAIN HEALTHY DURING A CONSTRUCTION PROJECT THEY MUST BE PROTECTED FROM CONSTRUCTION ACTIVITIES. TREE AND PLANT PROTECTION, THE FOLLOWING REQUIREMENTS APPLY TO ALL CONSTRUCTION SITES:
- TREES WITHIN THE CONSTRUCTION ZONE SHALL BE PROTECTED FROM DAMAGE AND SOIL COMPACTION BY EQUIPMENT, DEBRIS AND STORAGE INTRUSION. SUGGESTED MATERIALS FOR PROTECTION ARE CONCRETE BARRICADES, CONSTRUCTION FENCING OR CHAIN LINK FENCING AND NOTED ON CONTRACTOR'S SITE OPERATIONS LAYOUT.
- B. TREE PROTECTION SHALL BE PLACED AT A MINIMUM OF ONE AND A HALF (1.5) TIMES (IN FEET) THE CALIPER DIMENSION (IN INCHES) FROM THE BASE OF THE TRUNK. FOR EXAMPLE; A TEN (10) CALIPER INCH TREE WOULD REQUIRE PROTECTION A MINIMUM OF FIFTEEN (15) FEET FROM THE BASE OF THE
- TREES THAT ARE NECESSARILY IMPACTED BY CONSTRUCTION SHALL BE PRUNED AND ROOT PRUNED AS REQUIRED BY A CERTIFIED ARBORIST.
- 52. TRACER WIRES TO BE TERMINATED IN THE CORRECT COLOR COPPERHEAD TRACER WIRE BOX OR WITHIN A MANHOLE. LOCATION OF TRACER WIRE BOXES TO BE SHOWN ON AS-BUILT DRAWINGS.
- BE REMOVED AND COMPACTED SOILS DECOMPACTED TO A DEPTH OF 12" PRIOR TO INSTALLATION OF TOPSOIL. WITHIN LANDSCAPE AREAS ALL CLASS V MATERIAL SHALL BE REMOVED AND COMPACTED SOILS DECOMPACTED TO A DEPTH OF 12" PRIOR TO INSTALLATION OF TOPSOIL.
- 54. GENERAL CONTRACTOR SHALL TAKE PHOTOGRAPHS AND MEASUREMENTS OF ALL STORMWATER MANAGEMENT SYSTEMS THROUGHOUT CONSTRUCTION. DOCUMENTATION OF CONSTRUCTION SHALL BE SUBMITTED TO THE CIVIL ENGINEER AT THE CLOSEOUT OF THE PROJECT. CLOSEOUT DOCUMENTATION SHALL INCLUDE PHOTOGRAPHS AND MEASUREMENTS OF SYSTEM DURING CONSTRUCTION, TESTING REPORTS AND OBSERVATIONS AND REDLINE DRAWINGS OF ANY FIELD MODIFICATIONS MADE DURING CONSTRUCTION.
- 55. A LETTER WRITTEN ON COMPANY LETTERHEAD THAT THE STORMWATER MANAGEMENT PRACTICES HAVE BEEN BUILT PER THE CIVIL PLANS, OR PER REDLINE FIELD DRAWINGS. SHALL BE SUBMITTED TO THE CIVIL ENGINEER AT THE CLOSEOUT OF THE PROJECT.
- 56. THE GENERAL CONTRACTOR SHALL SUBMIT AN AS-BUILT SURVEY OF THE COMPLETED SITE PREPARED AND SIGNED BY A LICENSED SURVEYOR AT THE END OF THE PROJECT. UPON COMPLETION, THE CONTRACTOR MUST SUBMIT AN AS-BUILT SURVEY OF THE PROPERTY, IMPROVEMENTS AND UTILITY SERVICE LINES AND STRUCTURES; AND PROVIDE A CERTIFIED RECORD OF ALL PROJECT PLAN SHEETS DEPICTING ANY ASSOCIATED PRIVATE AND/OR PUBLIC IMPROVEMENTS, REVISIONS AND ADJUSTMENTS PRIOR TO ISSUANCE OF THE CERTIFICATE OF OCCUPANCY. THE

AS-BUILT SURVEY MUST ALSO VERIFY THAT ALL PROPERTY CORNERS HAVE BEEN ESTABLISHED AND ARE IN PLACE AT THE COMPLETION OF THE PROJECT AS DETERMINED AND DIRECTED BY THE CITY ENGINEER. AS-BUILT SURVEY SHALL INCLUDE ENOUGH INFORMATION TO VERIFY THE CONSTRUCTED TOPOGRAPHY AND SITE DRAINAGE, UTILITY RIMS, INVERTS AND SIZES AND ALL SITE PAVING, FEATURES AND ELEMENTS. COORDINATE WITH OWNER AND CIVIL ENGINEER FOR SCHEDULE FOR WHEN THIS SHALL BE COMPLETED. A CADD AND CERTIFIED PDF FILE MUST BE SUBMITTED TO ARCHITECT AND CIVIL ENGINEER AS WELL AS TO CITY ENGINEER.

BE PERFORMED BY THE DEVELOPER'S DESIGN/PROJECT ENGINEER. UPON PROJECT COMPLETION, THE DESIGN/PROJECT ENGINEER MUST FORMALLY CERTIFY THROUGH A LETTER THAT THE PROJECT WAS BUILT IN CONFORMANCE WITH THE APPROVED PLANS AND UNDER THE DESIGN/PROJECT ENGINEER'S IMMEDIATE AND DIRECT SUPERVISION. THE ENGINEER MUST BE CERTIFIED IN THE STATE OF MINNESOTA AND MUST CERTIFY ALL REQUIRED AS-BUILT DRAWINGS (WHICH ARE SEPARATE FROM THE AS-BUILT SURVEY).

LEGEND

EXISTING CONIFEROUS TREE

EXISTING FIRE HYDRANT

EXISTING WATER VALVE

EXISTING DOWNSPOUT

EXISTING POST

EXISTING BOLLARD

EXISTING METER

EXISTING CLEAN OUT

EXISTING WATER MANHOLE

EXISTING ELECTRIC MANHOLE

EXISTING SANITARY SEWER MANHOLE

EXISTING STORM SEWER MANHOLE

EXISTING COMMUNICATION PEDESTAL

EXISTING ELECTRIC TRANSFORMER

EXISTING ELECTRIC PEDESTAL

EXISTING CATCH BASIN

EXISTING LIGHT POLE

EXISTING WATER LINE

EXISTING SANITARY SEWER LINE

EXISTING STORM SEWER LINE

EXISTING OVERHEAD ELECTRIC LINE

EXISTING OVERHEAD COMMUNICATION LINE

EXISTING UNDERGROUND COMMUNICATION LINE

EXISTING UNDERGROUND ELECTRIC LINE

EXISTING UNDERGROUND GAS LINE

EXISTING UNDERGROUND FIBER LINE

EXISTING CHAIN LINK FENCE

EXISTING SPOT ELEVATIONS

PROPOSED SPOT ELEVATION

PROPOSED SAWCUT LINE

PROPOSED CATCH BASIN

PROPOSED MANHOLE

— » — » — PROPOSED STORM SEWER BY OTHERS

SILT FENCE

--->---> PROPOSED SANITARY SEWER BY OTHERS

TO BE REMOVED

TO BE REMOVED

TO BE REMOVED

BE REMOVED

EXISTING UTILITY TO BE REMOVED

SEE DETAIL

SEE DETAIL

SEE DETAIL

|+ + + + + +

RFMOVFD

EXISTING GRAVEL TO BE

PROPOSED GATE VALVE

EROSION CONTROL AT CB/MH

EXISTING CONCRETE SIDEWALK

EXISTING TREE TO BE REMOVED

EXISTING BITUMINOUS PAVEMENT

EXISTING CONCRETE PAVEMENT

EXISTING CONCRETE PAVEMENT

BE REMOVED BY OTHERS

EXISTING CURB AND GUTTER TO

PROPOSED BITUMINOUS PAVEMENT,

PROPOSED CONCRETE SIDEWALK,

PROPOSED CONCRETE PAVEMENT.

EXISTING CURB AND GUTTER TO

DENOTES SURFACE DRAINAGE

— PROPOSED CONTOUR

SAN>> PROPOSED SANITARY SEWER

STM> STM> PROPOSED STORM SEWER

PROPOSED WATERMAIN

- EXISTING OVERHEAD UTILITY LINE

EXISTING SIGN

_____E-D____

_____C-D-___

 $+ \overline{54.5}$

EXISTING TRAFFIC SIGNAL

57. INSPECTION FOR THE PRIVATE SITE IMPROVEMENTS MUST

SITE 1A & 1B ALATUS - MULTIFAMILY HOUSING 1 & ENTREPRENEURIAL MARKET EXISTING DECIDUOUS TREE CIVIL DRAWING INDEX

> CIVIL NOTES AND LEGEND SITE DEMOLITION PLAN ISWPPP NARRATIVE SWPPP SITE LAYOUT SWPPP DETAILS GRADING AND DRAINAGE PLAN UTILITY PLAN SITE LAYOUT AND PAVING PLAN CITY DETAILS CITY DETAILS

-SITE 1A & 1B ALATUS - MULTIFAMILY HOUSING 1 -SITE 1B **IMPERVIOUS AREA=2.822 ACRES** PERVIOUS AREA=0.498 ACRE **MARKET** TOTAL AREA=3.32 ACRES ر حوکم

ENTREPRENEURIAL RFWM - EVENT CENTER raw waa a PPL & RFWM -

MULTIFAMILY HOUSING

1"=150'

1 OVERALL DEVELOPMENT MAP 150 300

PPL & RFWM -

MULTIFAMILY HOUSING

ALATUS - MULTIFAMILY

HOUSING 2

PIERCE PINI & 9298 CENTRAL AVENUE NE, SUITE 312 BLAINE, MN 55434 TEL 763.537.1311

PROJECT TITLE

G R O U

Architecture

Engineering

Suite 101

55401

Interior Design

Landscape Architecture

222 North Second Street

Long & Kees Bldg

Minneapolis, MN

www.bkvgroup.com

CONSULTANTS

612.339.3752

BROOKLYN CENTER-ALATUS -**MULTIFAMILY** HOUSING '


05/10/2022 LAND USE APPLICATION 06/14/2022 LAND USE APPLICATION 3 06/22/2022 REVISION

CERTIFICATION

DRAWN BY CHECKED BY COMMISSION NUMBER SHEET TITLE ALATUS -**MULTIFAMILY**

HOUSING 1 - CIVIL NOTES AND LEGEND

SHEET NUMBER C100

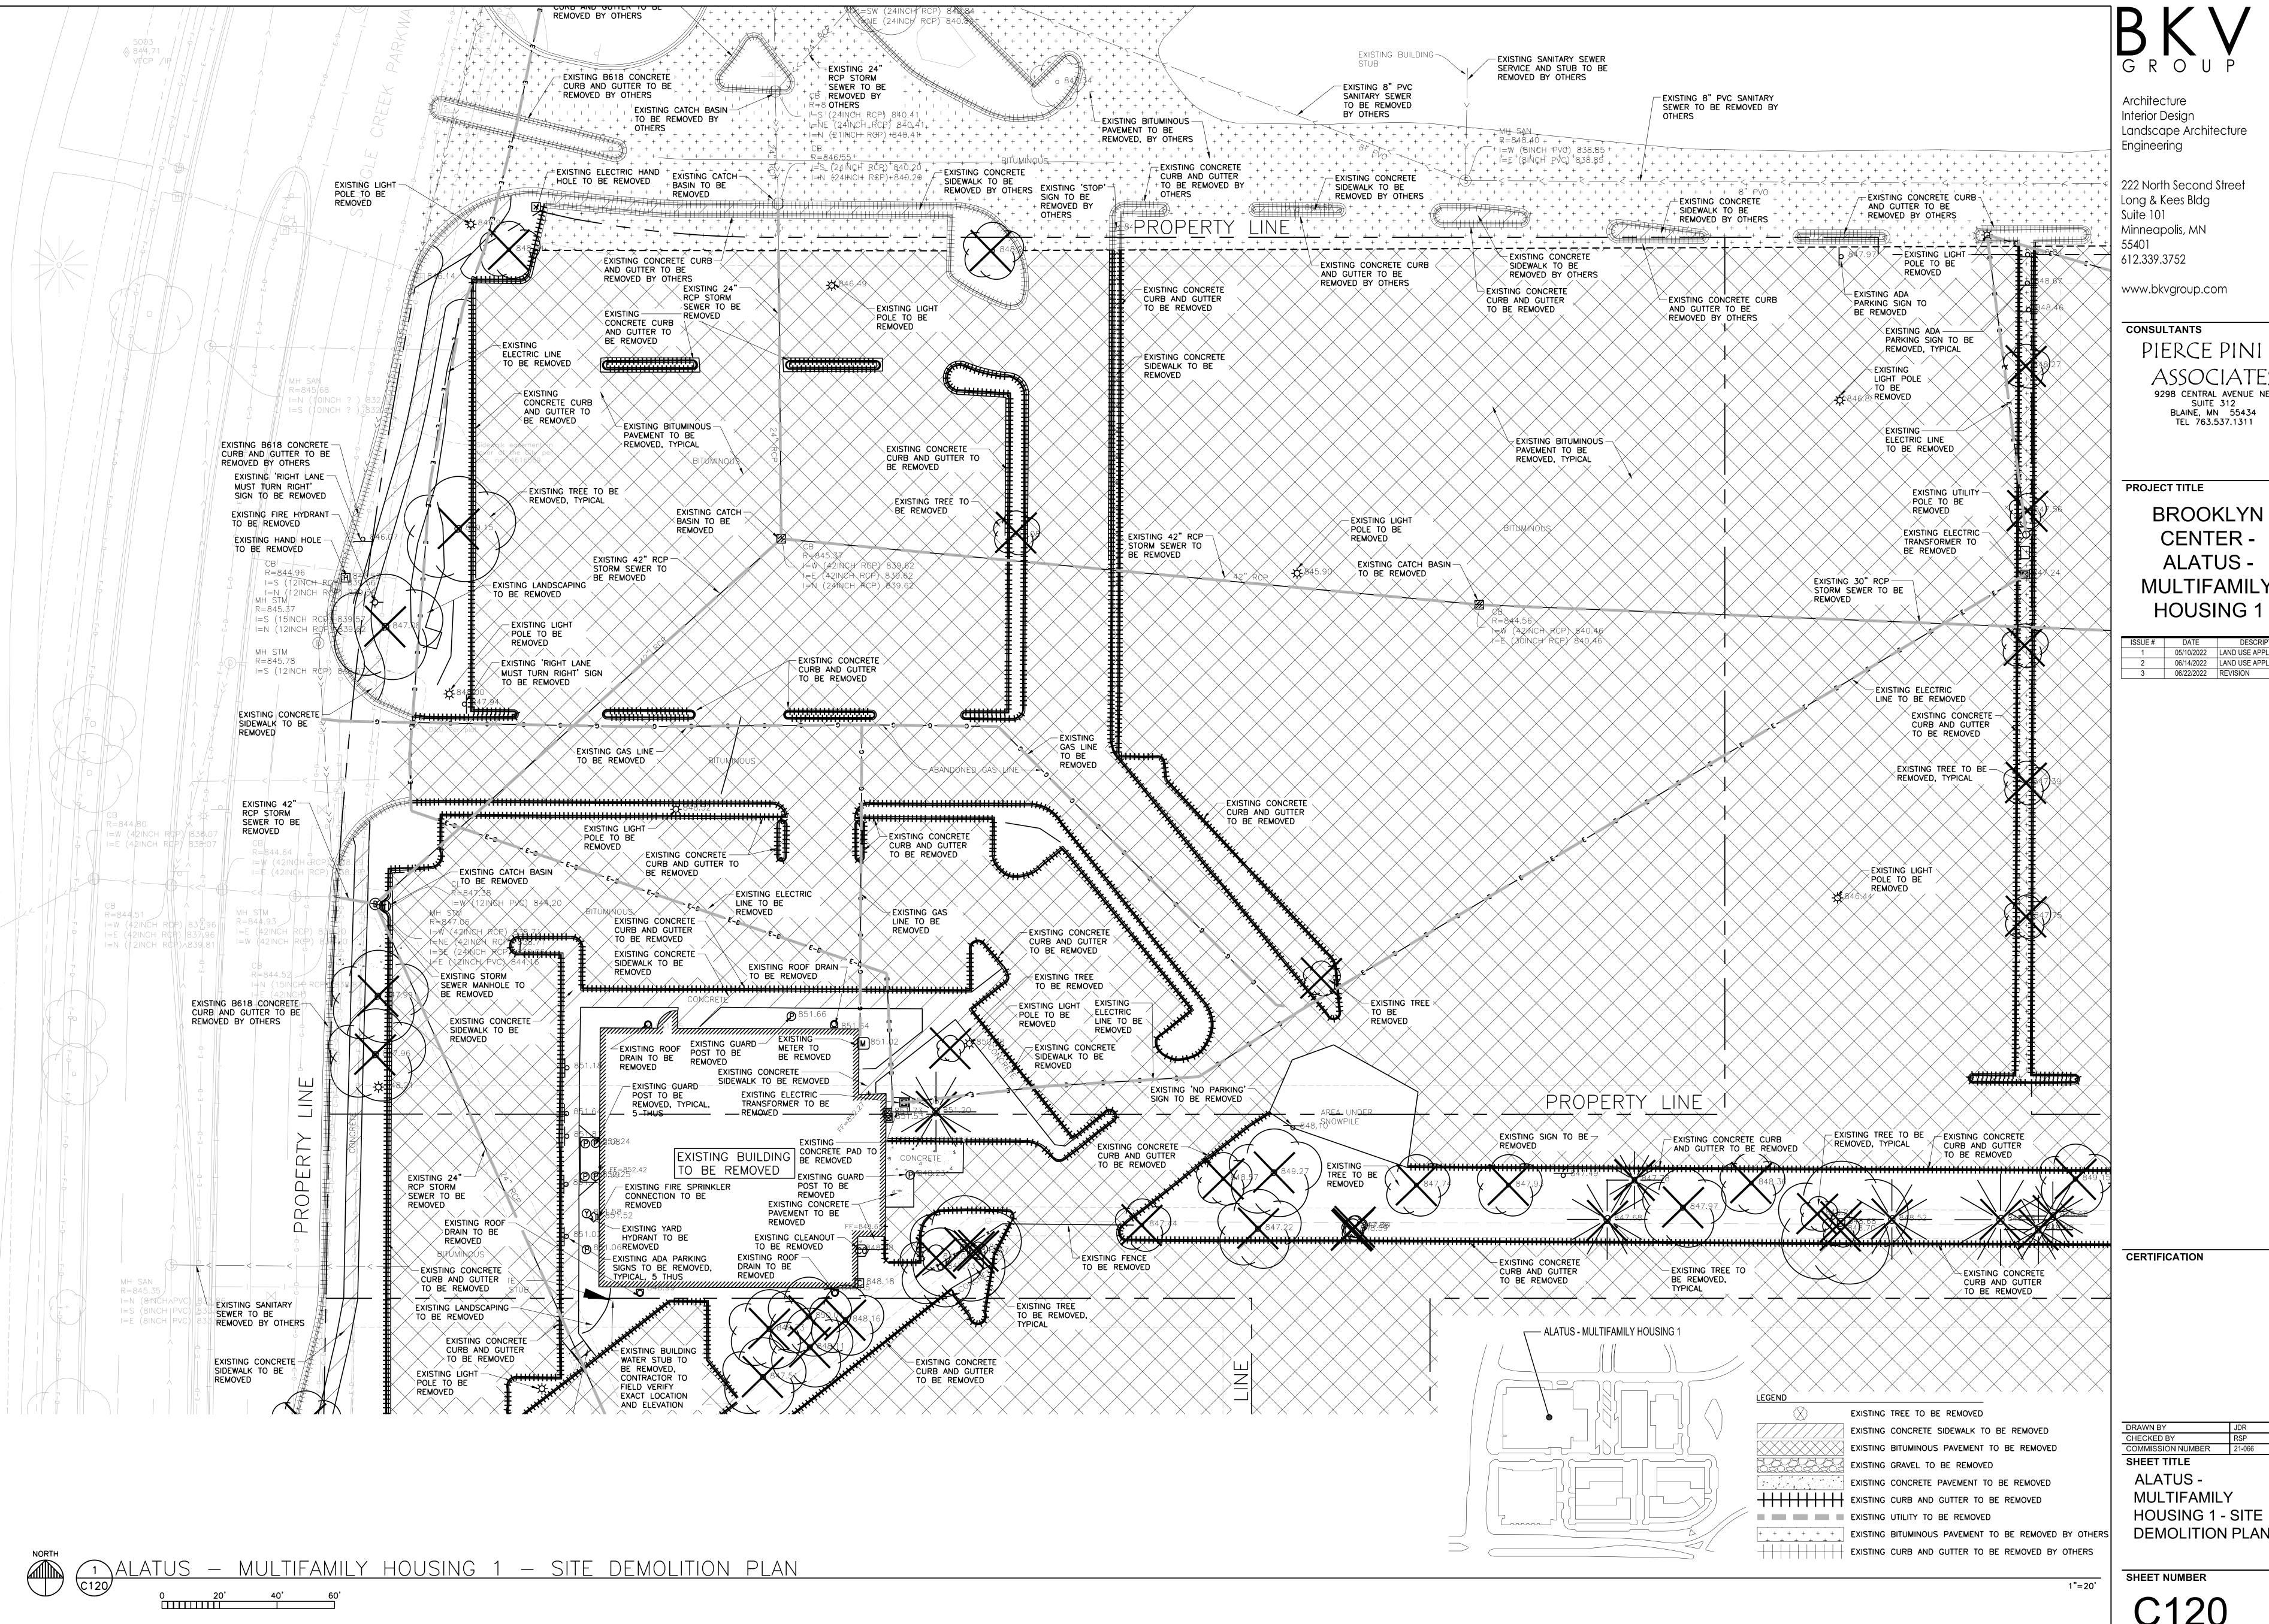

Interior Design Landscape Architecture Engineering

Long & Kees Bldg Suite 101 Minneapolis, MN

www.bkvgroup.com

CONSULTANTS 9298 CENTRAL AVENUE NE,

SUITE 312

TEL 763.537.1311

BROOKLYN **ALATUS -MULTIFAMILY HOUSING 1**

05/10/2022 LAND USE APPLICATION 06/14/2022 LAND USE APPLICATION 3 06/22/2022 REVISION

CERTIFICATION

DRAWN BY CHECKED BY COMMISSION NUMBER SHEET TITLE ALATUS -MULTIFAMILY

DEMOLITION PLAN

SHEET NUMBER

C120

SWPPP NARRATIVE

THIS STORMWATER POLLUTION PREVENTION PLAN (SWPPP) HAS BEEN COMPLETED TO FULFILL THE PERMIT REQUIREMENTS OF THE GENERAL CONSTRUCTION STORMWATER PERMIT (NPDES/SDS PERMIT) FOR EROSION AND SEDIMENT CONTROL FROM SITES WITH MORE THAN 1 ACRE OF SOIL DISTURBANCE. A PERMIT FROM THE MINNESOTA POLLUTION CONTROL AGENCY (MPCA) IS REQUIRED FOR THIS PROJECT.

THE CITY OF BROOKLYN CENTER AND SHINGLE CREEK WATERSHED MANAGEMENT COMMISSION (SCWMC) HAVE JURISDICTIONAL AUTHORITY FOR EROSION CONTROL, SOIL CONTROL AND STORMWATER MANAGEMENT AT THIS SITE. IN ADDITION TO THE PROVISIONS OF THE PERMIT. EROSION PREVENTION AND SEDIMENTATION CONTROL SPECIFICATIONS AND PLANS HAVE BEEN CREATED. MPCA PROCEDURES FOR APPLICATION, MAINTENANCE AND TERMINATION OF THE PERMIT ARE DESCRIBED IN THE SPECIFICATIONS. ADDITIONAL INFORMATION AND GENERAL CONTRACTOR REQUIREMENTS ARE CONTAINED IN THE SPECIFICATIONS THAT ARE NOT INCLUDED ON THIS SHEET. THE GENERAL CONTRACTOR MUST FOLLOW PERMIT REQUIREMENTS AT ALL TIMES; NOTHING IN THE SWPPP OR SPECIFICATIONS SUPERCEDES THE GENERAL CONTRACTORS RESPONSIBILITIES UNDER THE PERMIT.

THIS SWPPP MUST BE KEPT ONSITE AND UPDATED AS NECESSARY TO REFLECT CHANGES TO SITE CONDITIONS, PLACEMENT OF CONTROL MEASURES AND ELEMENTS ONSITE. THIS DOCUMENT IS REQUIRED TO REFLECT CURRENT CONDITIONS BASED ON SITE INSPECTIONS AND ACTIONS.

1. PROJECT DESCRIPTION/LOCATION

SEE STORMWATER MANAGEMENT CALCULATIONS AND REPORT AND SPECIFICATIONS FOR THIS SITE AND INCORPORATE INFORMATION INTO CONSTRUCTION PROCEDURES.

PROJECT NAME:	ALATUS - MULTIFAMILY HOUSING 1
PROJECT NUMBER:	21-066
PROJECT LOCATION:	BROOKLYN CENTER, MN
TOTAL DISTURBED AREA:	3.32 ACRES
PRE-CONSTRUCTION IMPERVIOUS SURFACE ACRES:	3.07 ACRES
POST-CONSTRUCTION IMPERVIOUS SURFACE ACRES:	2.82 ACRES
CUMULATIVE NEW IMPERVIOUS SURFACE ACRES:	N/A
WORK IN/NEAR WATER/CONVEYANCE?:	NO
ECOLOGICALLY SENSITIVE AREAS IN PROJECT SCOPE?:	NO
TEMPORARY BASIN IN PROJECT SCOPE*?:	NO
TYPE AND DESIGN CRITERIA OF PERMANENT BMPS IN PROJECT SCOPE**:	REGIONAL STORMWATER POND
PROJECT SCOPE**:	REGIONAL STORMWATER POND

**LONG TERM MAINTENANCE OF PROJECT BMPS WILL BE CONDUCTED BY THE OWNER AND THE CITY OF BROOKLYN CENTER. DESIGN CALCULATIONS AND DETAILS ARE MAINTAINED WITH THE CITY OF BROOKLYN CENTER'S CONSULTANT, BOLTON + MENK.

THE PLANNED SCOPE OF THE PROJECT INCLUDES:

- CONSTRUCTION OF A NEW MULTIFAMILY BUILDING, ENTREPRENEURIAL CENTER DRIVEWAYS AND SIDEWALKS.
- STORMWATER FROM THIS SITE WILL BE COLLECTED THROUGH A SERIES OF CATCH BASINS AND PIPES AND DISCHARGED TO A PROPOSED REGIONAL STORMWATER POND DESIGNED BY BOLTON + MENK.

o. SPECIAL AND IMPAIRED WATERS: THESE WETLANDS, FENS, TROUT STREAMS, ORVWS AND IMPAIRED WATERS ARE LOCATED WITHIN ONE MILE (AERIAL RADIUS) OF THE PROJECT LIMITS. SHINGLE CREEK IS AN IMPAIRED WATER WITHIN ONE MILE BUT WILL NOT BE AFFECTED OR IMPACTED BY THIS PROJECT.

WATER BODY NAME	REACH NUMBER	IMPAIRMENTS	APPLICABLE?
SHINGLE CREEK	07010206-506	CHLORIDE, DISSOLVED OXYGEN, E.COLI, INVERTBIO	N

3. ECOLOGICAL AND OTHER SENSITIVE AREAS

IN ADDITION TO ANY ADDITIONAL PROVISIONS DICTATED IN THE RESPECTIVE PART BELOW, THE GENERAL CONTRACTOR SHALI PROVIDE SPECIAL CARE AND ATTENTION TO ECOLOGICAL OR OTHER SENSITIVE AREA(S) INDICATED IN THIS SECTION TO PREVENT TRAFFIC AND DISTURBANCE, AND TO PRESERVE VEGETATIVE COVER IN IDENTIFIED AREAS. IDENTIFIED AREAS AND APPROPRIATE SETBACKS SHALL BE MARKED IN THE FIELD BY THE GENERAL CONTRACTOR, AS SPECIFIED IN SUBSEQUENT PAGE DETAILS, IF APPLICABLE.

a. PLACEMENT OF FILL IN WATERS OF THE STATE.

- b. DRINKING WATER SUPPLY MANAGEMENT AREA: THIS PROJECT IS LOCATED WITHIN A WELLHEAD PROTECTION AREA AND A MODERATELY VULNERABLE DRINKING WATER SUPPLY MANAGEMENT AREA (DWSMA). THE PROJECT IS NOT WITHIN A KNOWN KARST AREA. ADDITIONAL PROVISIONS APPLY TO THIS PROJECT.
- c. ENVIRONMENTAL REVIEW: THIS PROJECT IS NOT SUBJECT TO FINDINGS OF AN ENVIRONMENTAL, OR ARCHEOLOGICAL AND HISTORIC PLACES REVIEW. NO ADDITIONAL PROVISIONS APPLY TO THIS PROJECT.
- d. ENDANGERED OR THREATENED SPECIES: THERE ARE NO ENDANGERED OR THREATENED SPECIES AFFECTED BY THIS
- PROJECT. NO ADDITIONAL PROVISIONS APPLY TO THIS PROJECT. e. AQUATIC INVASIVE SPECIES, INFESTED WATERS AND WORK IN WATERS RESTRICTIONS: PROJECT SCOPE DOES NOT INCLUDE WORK IN OR NEAR PUBLIC WATERS. NO PUBLIC WATERS IN OR NEAR THE PROJECT SITE ARE LISTED OR
- SPECIALLY DESIGNATED BY THE MINNESOTA DEPARTMENT OF NATURAL RESOURCES DEPARTMENT OF WATER (DOW). f. SOIL TYPES TYPICALLY FOUND ON THIS PROJECT SITE ARE LOAMY SANDS ACCORDING TO THE USDA WEB SOIL

4. PROJECT PERSONNEL AND SWPPP IMPLEMENTATION RESPONSIBILITIES

ORGANIZATION	CONTACT NAME & CERTIFICATION NUMBER	PHONE
OWNER: ALATUS	CHRIS OSMUNDSON	612-455-0912
ENGINEER FIRM NAME	PIERCE PINI + ASSOCIATES, INC.	763-537-1311
SWPPP PREPARER: PIERCE PINI AND ASSOCIATES	RHONDA PIERCE, P.E.	763-537-1311
GENERAL CONTRACTOR FIRM NAME:		
SOIL/EROSION CONSTRUCTION SITE MANAGER		
SOIL/EROSION CONSTRUCTION SITE MANAGER		

MPCA DUTY OFFICER 24-HOUR EMERGENCY SPILL NOTIFICATION: 651-649-5451 OR 800-422-0798

- a. THE OWNER AND THE NAMED GENERAL CONTRACTOR ARE CO-PERMITTEES FOR THE GENERAL CONSTRUCTION STORMWATER PERMIT (NPDES/SDS PERMIT). THE GENERAL CONTRACTOR IS RESPONSIBLE TO COMPLY WITH ALL ASPECTS OF THE PERMIT AND STORMWATER COMPLIANCE POLICY AT ALL TIMES UNTIL THE NOTICE OF TERMINATION (NOT) HAS BEEN FILED WITH THE MPCA.
- b. THE GENERAL CONTRACTOR SHALL DEVELOP A CHAIN OF COMMAND WITH ALL OPERATORS ON THE SITE TO ENSURE THAT THE SWPPP IS IMPLEMENTED AND MAINTAINED UNTIL THE PROJECT IS COMPLETE, THE ENTIRE SITE HAS UNDERGONE FINAL STABILIZATION, AND OWNER HAS COMPLETED THE FINAL INSPECTION
- c. THE PROJECT ENGINEER OF RECORD IS RESPONSIBLE FOR THE DESIGN OF THE SWPPP. THE GENERAL CONTRACTOR IS RESPONSIBLE FOR IMPLEMENTATION OF THE SWPPP AND THE INSTALLATION, INSPECTION AND MAINTENANCE OF THE EROSION PREVENTION AND SEDIMENT CONTROL BEST MANAGEMENT PRACTICES (BMPS) DESCRIBED BY THE SWPPP AT ALL STAGES OF CONSTRUCTION UNTIL THE OWNER HAS COMPLETED THE FINAL INSPECTION.
- d. THE GENERAL CONTRACTOR SHALL BE RESPONSIBLE FOR ALL ON-SITE IMPLEMENTATION OF THE SWPPP INCLUDING THE ACTIVITIES OF ALL OF SUBCONTRACTORS DURING CONSTRUCTION. e. GENERAL CONTRACTOR SHALL PROVIDE AT LEAST ONE CERTIFIED INSTALLER FOR EACH SUBCONTRACTOR TO OVERSEE
- ALL INSTALLATION AND MAINTENANCE OF BMPS AND IMPLEMENTATION OF THE SWPPP. CERTIFICATION IS THROUGH THE UNIVERSITY OF MINNESOTA EROSION AND STORMWATER MANAGEMENT CERTIFICATION PROGRAM (http://www.erosion.umn.edu/) OR APPROVED EQUIVALENT.
- f. General contractor shall provide at least one certified individual to conduct inspection and MAINTENANCE OF ALL EROSION PREVENTION AND SEDIMENT CONTROL BMPS IN ACCORDANCE WITH THE REQUIREMENTS OF THE PERMIT. GENERAL CONTRACTOR SHALL PROVIDE EVIDENCE OF CERTIFICATION FOR EACH INDIVIDUAL AT THE PRE-CONSTRUCTION MEETING AND IS MAINTAINED BY GENERAL CONTRACTOR WITH PROJECT
- g. THIS SWPPP HAS BEEN PREPARED BY INDIVIDUAL(S) TRAINED IN ACCORDANCE WITH THE PERMIT'S TRAINING REQUIREMENTS FOR PREPARATION OF SWPPPS.

PREPARED BY: RHONDA PIERCE, P.E. PIERCE PINI AND ASSOCIATES RHONDA@PIERCEPINI.COM

763-537-1311

TRAINING/CERTIFICATION: DATE OF TRAINING/CERTIFICATION: 2020 INSTRUCTOR(S): JOHN CHAPMAN

CERTIFICATION EXPIRATION: MAY 31, 2023

5. <u>SEQUENCE OF CONSTRUCTION</u>

THE FOLLOWING DESCRIBES, IN GENERAL, THE SEQUENCE OF WORK PERFORMED ON THE SITE:

- a. GENERAL CONTRACTOR SHALL VERIFY THAT ALL PERMITS HAVE BEEN OBTAINED AND/OR OBTAIN THE NECESSARY PERMITS IN ACCORDANCE WITH THE MPCA POLICY.
- b. GENERAL CONTRACTOR SHALL INSTALL ALL PERIMETER AND DOWN-GRADIENT EROSION CONTROL AND SEDIMENT CONTROL BMPS, INCLUDING CONSTRUCTION ENTRANCES AND INLET PROTECTION DEVICES PRIOR TO SITE GRADING, EXCAVATION. STOCKPILING OR DISTURBING EXISTING VEGETATIVE COVER. GENERAL CONTRACTOR SHALL INSTALL ALL DOWN-GRADIENT PERIMETER CONTROLS BEFORE ANY UP-GRADIENT DISTURBANCE BEGINS.
- c. THE GENERAL CONTRACTOR SHALL ATTEMPT TO PHASE ALL WORK TO MINIMIZE EROSION AND MAINTAIN VEGETATIVE COVER TO THE EXTENT POSSIBLE. PRESERVE ALL NATURAL BUFFERS SHOWN ON PLAN.

- d. GENERAL CONTRACTOR SHALL MARK OR OTHERWISE DELINEATE AREAS ON THE SITE NOT TO BE DISTURBED, INCLUDING ECOLOGICALLY SENSITIVE AREAS, BEFORE CONSTRUCTION BEGINS.
- e. GENERAL CONTRACTOR SHALL ESTABLISH SITE LOCATION AND COMPLETE INSTALLATION OF ANY PORTABLE TOILET FUELING AREA, SPILL KIT LOCATION, CONCRETE WASHOUT AREA, HAZARDOUS MATERIAL HANDLING AND STORAGE AREA, LITTER CONTROL DEVICE AREA, STAGING AREA, STOCK PILING AREA, AND OTHER SWPPP DESIGNATED AREAS. UPDATE ONSITE-COPY OF SWPPP TO REFLECT LOCATION OF THESE ITEMS.
- f. GENERAL CONTRACTOR SHALL ESTABLISH AND ENFORCE PROTOCOL REGARDING CLEANING OF ALL EQUIPMENT THAT HAS BEEN USED IN INFESTED WATERS OR WATERS WITH INVASIVE SPECIES TO PREVENT THE SPREAD OF BOTH AQUATIC AND TERRESTRIAL INVASIVES. GENERAL CONTRACTOR SHALL OBTAIN VERIFICATIONS FROM ALL SUBCONTRACTORS THAT EQUIPMENT IS CLEAN, OR NEW, AND WILL NOT SPREAD INVASIVES.
- g. GENERAL CONTRACTOR IS RESPONSIBLE FOR MEANS AND METHODS OF SITE DEWATERING. DEWATERING SHALL FOLLOW MPCA AND CITY OF BROOKLYN CENTER STANDARDS AND REQUIREMENTS. SUBMIT PLAN OF ACTION FOR
- h. GENERAL CONTRACTOR SHALL ESTABLISH AND ENFORCE TRAFFIC FLOW AND PATTERNS, INCLUDING HAUL ROADS, AT PROJECT SITE TO MINIMIZE SOIL DISTURBANCE, TRACKING AND COMPACTION, AND TO PRESERVE NATIVE AND EXISTING VEGETATION. UPDATE ONSITE COPY OF SWPPP TO REFLECT HAUL ROADS AND OTHER SITE TRAFFIC PATTERNS. i. GENERAL CONTRACTOR SHALL PERFORM SITE GRADING, EXCAVATION, STOCKPILING WORK IN ACCORDANCE WITH THE
- A. STOCKPILES SHALL BE PROTECTED AROUND THE ENTIRE PERIMETER WHEN NOT ACTIVELY BEING WORKED; STOCKPILES ACTIVELY BEING WORKED SHALL BE STABILIZED AT THE END OF EACH WORK DAY. PRESERVED TOPSOIL STOCKPILES SHALL ADDITIONALLY BE COVERED. $\,$ PLACE BMP A MINIMUM OF 5 FEET FROM THE TOE OF THE SLOPE WHERE FEASIBLE. STABILIZE ALL ERODABLE STOCKPILES.
- B. DO NOT PLACE STOCKPILES IN NATURAL BUFFER AREAS, SURFACE WATERS OR STORMWATER CONVEYANCES INCLUDING GUTTERS OR SWALES.
- C. MINIMIZE SOIL COMPACTION AND PRESERVE TOPSOIL, UNLESS INFEASIBLE. MINIMIZING SOIL COMPACTION IS NOT REQUIRED WHERE THE FUNCTION OF A SPECIFIC AREA OF THE SITE DICTATES THAT IT BE COMPACTED. GENERAL CONTRACTOR SHALL PROVIDE GRADING AND BMP INSTALLATION TO LIMIT SOIL EXPOSURE ON ALL SLOPES OF 3H:1V OR STEEPER TO AN UNBROKEN LENGTH OF 75 FEET OR LESS.
- k. GENERAL CONTRACTOR SHALL STABILIZE ALL EXPOSED SOILS NO LATER THAN 7 DAYS AFTER THE CONSTRUCTION ACTIVITY IN THAT PORTION OF THE SITE HAS TEMPORARILY OR PERMANENTLY CEASED.
- A. GENERAL CONTRACTOR SHALL MAINTAIN 70% VEGETATIVE COVER ON COMPLETED AREAS OF THE PROJECT SITE. B. STABILIZE ALL AREAS OF THE SITE PRIOR TO THE ONSET OF WINTER. C. STABILIZE WETTED PERIMETER OF DITCH (I.E. WHERE THE DITCH GETS WET).
- WHEN PERMANENT BMPS OR PORTIONS THEREOF ARE INSTALLED, GENERAL CONTRACTOR SHALL STAKE OR MARK THESE AREAS, AND INSTALL SEDIMENT PROTECTION UPGRADIENT OF COMPLETED AREAS TO AVOID COMPACTION AND FOULING OF SYSTEM ELEMENTS. PERMANENT BMPS SHALL BE CONSTRUCTED AND STABILIZED TO THE EXTENT PRACTICABLE PRIOR TO BEING PLACED INTO SERVICE. IN THE EVENT THAT PERMANENT STABILIZATION CANNOT BE ACHIEVED BEFORE BEING PLACED INTO SERVICE, TEMPORARY MEASURES TO PREVENT FOULING SHALL BE IN PLACE
- m. GENERAL CONTRACTOR SHALL PERFORM SITE RESTORATION ACTIVITIES FOR PERMANENT VEGETATIVE ESTABLISHMENT. TEMPORARY BMPS SUCH AS MULCH AND HYDROSEED DO NOT CONSTITUTE PERMANENT VEGETATIVE COVER; SOD INSTALLATION MAY CONSTITUTE PERMANENT VEGETATIVE COVER.
- n. THE GENERAL CONTRACTOR SHALL ENSURE FINAL STABILIZATION: A. ALL SOIL DISTURBING ACTIVITIES ARE COMPLETE AND A UNIFORM PERENNIAL VEGETATIVE COVER WITH A DESTINY OF 70% OVER THE ENTIRE PERVIOUS SURFACE HAS BEEN ACHIEVED, INCLUDING STABILIZATION OF
- B. GENERAL CONTRACTOR SHALL ENSURE THAT ALL PERMANENT STORMWATER TREATMENT SYSTEMS ARE
- CONSTRUCTED IN ACCORDANCE WITH THE PLANS AND SPECIFICATIONS IF INCLUDED WITHIN THE SCOPE OF
- C. GENERAL CONTRACTOR SHALL REMOVE ALL TEMPORARY SYNTHETIC AND STRUCTURAL BMPS, EXCEPT AS SPECIFICALLY AUTHORIZED/REQUIRED BY CITY OF BROOKLYN CENTER. D. GENERAL CONTRACTOR SHALL REMOVE ALL SEDIMENTS FROM STORMWATER CONVEYANCES AND PERMANENT
- WATER QUALITY BASINS. E. GENERAL CONTRACTOR SHALL REQUEST A FINAL INSPECTION FROM THE CITY OF BROOKLYN CENTER PRIOR TO
- INITIATING PERMIT TERMINATION.

o. PERMIT SHALL BE TERMINATED IN ACCORDANCE WITH MPCA POLICY.

6. SITE INSPECTION AND MAINTENANCE

- a. INSPECT THE ENTIRE CONSTRUCTION SITE AND DOWNGRADIENT ADJACENT SITES/AREAS, INCLUDING THE FOLLOWING: A. INSPECT SURFACE WATER, INCLUDING DRAINAGE DITCHES, AND OFF-SITE PROPERTIES FOR SIGNS OF EROSION AND SEDIMENT DEPOSITION.
 - B. INSPECT CONSTRUCTION SITE VEHICLE EXIT LOCATIONS FOR EVIDENCE OF TRACKING ONTO PAVED SURFACES. C. INSPECT INFILTRATION AREAS FOR SIGNS OF SEDIMENT DEPOSITION AND COMPACTION, AND TO ENSURE
 - EQUIPMENT IS NOT BEING DRIVEN INTO THE AREA. D. INSPECT, MONITOR AND MAINTAIN ALL WATER QUALITY MANAGEMENT, EROSION PREVENTION AND SEDIMENT
- CONTROL BMPS. E. INSPECT, MONITOR AND MAINTAIN POLLUTION PREVENTION BMPS.
- b. INSPECTION FREQUENCY: GENERAL CONTRACTOR SHALL CONDUCT A SITE STORMWATER INSPECTION A MINIMUM OF ONCE EVERY SEVEN DAYS DURING ACTIVE CONSTRUCTION AND WITHIN 24 HOURS AFTER A RAINFALL EVENT GREATER THAN 0.5 INCHES IN 24 HOURS. INSPECTIONS MAY BE SUSPENDED DUE TO FROZEN GROUND CONDITIONS UNTIL FIRST RUNOFF OCCURS OR CONSTRUCTION ACTIVITIES RESUME, WHICHEVER COMES FIRST. GENERAL CONTRACTOR SHALL NOTE EXACT DATE OF LAST INSPECTION PRIOR TO WINTER SUSPENSION AND FIRST DATE WHEN CONSTRUCTION RESUMES. THE GENERAL CONTRACTOR IS RESPONSIBLE FOR INSPECTIONS UNTIL THE SITE HAS UNDERGONE FINAL STABILIZATION AND THE NOT HAS BEEN SUBMITTED TO THE MPCA, OR UNTIL PERMIT COVERAGE HAS BEEN TRANSFERRED TO ANOTHER PERMITTEE.
- c. RECORD ALL INSPECTIONS, MAINTENANCE AND CORRECTIVE ACTIONS CONDUCTED DURING CONSTRUCTION ON A PROVIDED INSPECTION FORM WITHIN 24 HOURS OF THE ACTION. DATE AND INITIAL THE ON-SITE SWPPP WITH ANY CHANGES TO REFLECT ON-SITE CONDITIONS. COPIES OF ALL SHALL BE SUBMITTED TO THE CIVIL ENGINEER.
- d. ALL EROSION CONTROL MEASURES MUST BE INSTALLED AND MAINTAINED BY GENERAL CONTRACTOR ACCORDING TO THE DETAILS INCLUDED IN THE CONSTRUCTION DOCUMENTS AND IN ACCORDANCE WITH THE PRODUCT MANUFACTURER'S RECOMMENDATIONS. BMPS MUST BE OPERATIONALLY FUNCTIONAL AND ADEQUATE. ALL NONFUNCTIONAL BMPS MUST BE REPAIRED OR REPLACED WITHIN 24 HOURS OF DISCOVERY OR THEREAFTER AS SOON AS FIELD CONDITIONS ALLOW.
- e. THE GENERAL CONTRACTOR SHALL RESPOND TO CHANGING SITE CONDITIONS AND IMPLEMENT/SUPPLEMENT EROSION PREVENTION AND SEDIMENT CONTROL MEASURES UTILIZED TO PROVIDE ADEQUATE PROTECTION OF DISTURBED SOILS AND ADEQUATE PREVENTION OF SEDIMENT TRANSPORT OFF-SITE. UPDATE SWPPP DOCUMENTS WHEN CHANGES ARE
- WHEN AN INSPECTION FINDS EROSION PREVENTION AND SEDIMENT CONTROL BMPS THAT ARE NONFUNCTIONAL OR INADEQUATE, ANY NONFUNCTIONAL BMPS MUST BE REPAIRED, REPLACED, OR SUPPLEMENTED WITH FUNCTIONAL BMPS WITHIN 24 HOURS AFTER DISCOVERY OR THEREAFTER AS SOON AS FIELD CONDITIONS ALLOW. THE GENERAL CONTRACTOR SHALL ALSO PLACE ANY ADDITIONAL EROSION CONTROL MEASURES DEEMED NECESSARY BY THE CITY OF BROOKLYN CENTER OR A/E WITHIN 24 HOURS OF NOTICE.
 - A. IF DOWN GRADIENT SEDIMENT CONTROLS ARE OVERLOADED, THE GENERAL CONTRACTOR MUST INSTALL ADDITIONAL UPGRADIENT SEDIMENT CONTROL PRACTICES OR REDUNDANT BMPS TO ELIMINATE OVERLOADING.
- THE SWPPP MUST BE AMENDED TO IDENTIFY THESES ADDITIONAL PRACTICES g. REPAIR OR REPLACE INLET PROTECTION DEVICES WHEN THEY BECOME NONFUNCTIONAL OR SEDIMENT REACHES ONE-HALF THE DEPTH OF THE DEVICE. SITE INLETS REMOVED IN RESPONSE TO A PUBLIC SAFETY CONCERN MUST BE RETURNED TO SERVICE AS SOON AS THE THREAT (EG. FLOODING) HAS RECEDED.
- h. REPAIR, REPLACE OR SUPPLEMENT PERIMETER CONTROL DEVICES WHEN THEY BECOME NON-FUNCTIONAL OR THE SEDIMENT REACHES ONE—HALF THE HEIGHT OF THE DEVICE. GENERAL CONTRACTOR SHALL REPAIR OR REPLACE DEVICE THAT IS NONFUNCTIONAL BY THE END OF THE NEXT BUSINESS DAY AFTER DISCOVERY OR THEREAFTER AS SOON AS FIELD CONDITIONS ALLOW. PERIMETER CONTROL DEVICES REMOVED IN RESPONSE TO A PUBLIC SAFETY CONCERN MUST BE RETURNED TO SERVICE AS SOON AS THE THREAT HAS RECEDED.
- TEMPORARY AND PERMANENT SEDIMENTATION BASINS MUST BE DRAINED AND SEDIMENT REMOVED BY GENERAL CONTRACTOR ONCE THE SEDIMENT COLLECTED REACHES ONE-HALF THE STORAGE VOLUME WITHIN 72 HOURS OF
- DISCOVERY, OR AS SOON AS FIELD CONDITIONS ALLOW. ALL SEDIMENT DEPOSITS WITHIN SURFACE WATERS OR STORMWATER CONVEYANCES MUST BE REMOVED AND RESTABILIZED BY GENERAL CONTRACTOR WITHIN 7 DAYS OF DISCOVERY, INCLUDING DELTAS AND STORM SEWER SEDIMENT DEPOSITS. THE GENERAL CONTRACTOR SHALL BE RESPONSIBLE FOR OBTAINING ALL PERMITS REQUIRED, IF NECESSARY, FOR SUCH SEDIMENT REMOVAL.
- MAINTAIN EXISTING PAVED SURFACES CLEAN OF SEDIMENT. CONSTRUCTION ENTRANCES AND PUBLIC AND PRIVATE ROADS LEADING TO AND FROM THE CONSTRUCTION ENTRANCE SHALL BE CHECKED DAILY BY GENERAL CONTRACTOR. IF THE ENTRANCE BECOMES INUNDATED WITH SEDIMENT, THE GENERAL CONTRACTOR SHALL CLEAN OR REPLACE AS APPROPRIATE. PUBLIC AND PRIVATE ROADS LEADING TO AND FROM THE CONSTRUCTION ENTRANCE SWEPT OR OTHERWISE CLEANED DAILY. GENERAL CONTRACTOR SHALL EXTEND SWEEPING TO THE EXTREMITY OF ANY SEDIMENT TRACKING THAT OCCURS OFF-SITE. USE MECHANICAL METHODS TO REMOVE SOLIDS FIRST, FOLLOWED BY WET METHODS, ONLY AS NEEDED. SWEEPING IS NOT A SUBSTITUTE FOR PROPER MAINTENANCE OF CONSTRUCTION
- GENERAL CONTRACTOR SHALL REMOVE ANY OFF-SITE SEDIMENT ACCUMULATIONS IN A MANNER AND AT A FREQUENCY SUFFICIENT TO MINIMIZE OFF-SITE IMPACTS. STREET SWEEPING MAY HAVE TO OCCUR MORE FREQUENTLY THAN DESCRIBED ABOVE TO MINIMIZE OFF-SITE IMPACTS. THERE ARE DOWNSTREAM WATERWAYS THAT WOULD BE ADVERSELY AFFECTED BY VEHICULAR TRACKED SOILS. STREET SWEEPING IS IMPERATIVE TO MAKES SURE THIS DOES NOT OCCUR.
- m. ALL INFILTRATION/FILTRATION AREAS MUST BE INSPECTED BY GENERAL CONTRACTOR TO ENSURE THAT NO SEDIMENT FROM ONGOING CONSTRUCTION IS ACCUMULATING OVER THE INFILTRATION/FILTRATION AREA. SEDIMENT ACCUMULATED OVER INFILTRATION/FILTRATION MUST BE REMOVED BY GENERAL CONTRACTOR
- n. SEE CIVIL NOTES, DETAILS AND DRAWINGS ON CONSTRUCTION DOCUMENTS.

7. POLLUTION PREVENTION AND SPILL RESPONSE

ENTRANCES.

- GENERAL CONTRACTOR SHALL BE RESPONSIBLE FOR IMPLEMENTING POLLUTION PREVENTION MEASURES AT THE SITE. AS DESCRIBED IN DETAIL IN THE EROSION PREVENTION AND SEDIMENTATION CONTROL SPECIFICATIONS SECTION 312500. IN GENERAL, THE FOLLOWING MEASURES ARE REQUIRED AT PROJECT SITES.
- a. BUILDING MATERIALS AND WASTES WITH THE POTENTIAL TO CONTAMINATE STORMWATER SHALL BE STORED INSIDE OR UNDER COVER IN A DESIGNATED AREA, AND SHALL BE INDICATED BY THE GENERAL CONTRACTOR ON THE SWPPP
- b. LITTER AND SOLID WASTE SHALL BE PLACED INTO COVERED CONTAINERS AT A DESIGNATED AREA AT THE SITE AND SHALL BE INDICATED BY THE GENERAL CONTRACTOR ON THE SWPPP SITE MAP.
- c. ON-SITE FUELING SHALL BE CONDUCTED IN DESIGNATED AREAS ONLY AND SHALL BE INDICATED BY THE GENERAL CONTRACTOR ON THE SWPPP SITE MAP.
- d. A SPILL RESPONSE KIT AT EACH LOCATION SPECIFIC TO THE MATERIALS USED AT THE PROJECT SITE AND SHALL BE INDICATED BY THE GENERAL CONTRACTOR ON THE SWPPP SITE MAP.
- e. PORTABLE TOILETS SHALL BE SECURED IN PLACE TO PREVENT BEING TIPPED OR KNOCKED OVER AND SHALL BE INDICATED BY THE GENERAL CONTRACTOR ON THE SWPPP SITE MAP.
- f. VEHICLE AND EQUIPMENT WASHING IS PROHIBITED AT PROJECT SITES.
- g. CONCRETE WASH OUT WASTE, INCLUDING WASTE CURED CONCRETE. SHALL BE MANAGED OFF-SITE OR MANAGED ON-SITE IN A DESIGNATED CONCRETE WASHOUT AREA AND SHALL BE INDICATED BY THE GENERAL CONTRACTOR ON THE SWPPP SITE MAP. ON-SITE BATCH PLANTS AND MORTAR MIX AREAS ARE CONCRETE PRODUCTS AND SHALL FOLLOW ALL STORMWATER MANAGEMENT CONTROLS AS NOTED HEREIN AND WITHIN NPDES PERMIT.
- h. THE GENERAL CONTRACTOR SHALL USE OR ENSURE USE OF METHODS AND OPERATIONS WHICH PREVENT DUST, PARTICLES, PIECES AND SLURRY FROM DEPOSITING IN VEGETATED OR FUTURE VEGETATED AREAS OR FROM LEAVING THE PROJECT SITE AND ENTERING A STORMWATER CONVEYANCE SYSTEM, INCLUDING A DITCH OR CULVERT.
- i. IN THE EVENT OF A SPILL AT THE PROJECT SITE WITH A RELEASE OR POTENTIAL RELEASE TO THE ENVIRONMENT, THE GENERAL CONTRACTOR SHALL CONTACT WITH THE STATE DUTY OFFICER.

8. PERMANENT STORMWATER PRACTICES

- a. CONSTRUCTION SEQUENCING OF STORM SEWER PRACTICES:
- A. STORM SEWER ROUTING DESIGN IS PROVIDED ON THE UTILTY PLANS. B. INSTALLATION OF STORM SEWER PRACTICES SHALL BE DONE DURING PERIODS OF DRY WEATHER AND
- COMPLETED BEFORE A RAINFALL EVENT. C. SHOP DRAWINGS OF ALL SYSTEMS NEED TO BE APPROVED PRIOR TO CONSTRUCTION.
- D. NOTIFY CIVIL ENGINEER OF WORK BEING DONE ON STORM SEWER SYSTEMS AND THE SCHEDULE OF CONSTRUCTION.
- E. MAINTAIN EROSION AND SEDIMENT CONTROL ON CONTRIBUTING AREAS TO AVOID CLOGGING OF SYSTEM. F. CONSTRUCT STORM SEWER SYSTEMS PER DRAWINGS AND SPECIFICATIONS. G. COMPLETE CONSTRUCTION OF PAVEMENT AFTER STORM SEWER SYSTEM IS INSTALLED. AFTER PAVEMENT IS
- INSTALLED, VERIFY THAT SYSTEMS ARE CLEAR AND FULLY FUNCTIONAL. VACUUM AND CLEAN SYSTEMS AS NEEDED SO THEY ARE FULLY FUNCTIONAL AT PROJECT CLOSEOUT. H. INSTALL LANDSCAPING AND PLANTING MATERIALS PER LANDSCAPE DRAWINGS AND SPECIFICATIONS.
- I. REMOVE ALL TEMPORARY EROSION CONTROL BMP'S AFTER PAVING IS COMPLETE AND TURF HAS BEEN ESTABLISHED.
- J. GENERAL CONTRACTOR SHALL TAKE PHOTOGRAPHS AND MEASUREMENTS OF ALL STORM SEWER SYSTEMS THROUGHOUT CONSTRUCTION. DOCUMENTATION OF CONSTRUCTION SHALL BE SUBMITTED TO THE CIVIL ENGINEER AT THE CLOSEOUT OF THE PROJECT. CLOSEOUT DOCUMENTATION SHALL INCLUDE PHOTOGRAPHS AND MEASUREMENTS OF SYSTEM DURING CONSTRUCTION, TESTING REPORTS AND OBSERVATIONS AND REDLINE DRAWINGS OF ANY FIELD MODIFICATIONS MADE DURING CONSTRUCTION.
- K. THE GENERAL CONTRACTOR SHALL SUBMIT AN AS-BUILT SURVEY OF THE COMPLETED SITE PREPARED AND SIGNED BY A LICENSED SURVEYOR TO THE CIVIL ENGINEER AT THE END OF THE PROJECT. AS-BUILT SURVEY SHALL INCLUDE ENOUGH INFORMATION TO VERIFY THE CONSTRUCTED TOPOGRAPHY, UTILITY AND SITE ELEMENTS. COORDINATE WITH OWNER AND CIVIL ENGINEER FOR SCHEDULE FOR WHEN THIS SHALL BE COMPLETED. A COPY OF THE CADD FILE AND CERTIFIED PDF FILE SHALL BE PROVIDED TO CIVIL ENGINEER.

L. GENERAL CONTRACTOR TO COMPLETE NOTICE OF TERMINATION (NOT) UPON COMPLETION OF PROJECT AND


SUBMIT TO OWNER. M. SEE NOTES ON SHEET C100 AND SPECIFICATION 312500 FOR FURTHER INFORMATION.

HYDROLOGIC SOIL GROUP SOIL ASSOCIATION

POORLY GRADED SAND (SP)

ESTIMATED BMP QUAN	TITIES
SILT FENCE	2,000 LF
FILTER LOGS	1,000 LF
CATCH BASIN INSERTS	16 EA
ROCK CONSTRUCTION ENTRANCE	40 CY EA.

QUANTITIES ARE FOR INFORMATIONAL PURPOSES ONLY. CONTRACTOR SHALL DETERMINE FOR THEMSELVES THE EXACT QUANTITIES FOR BIDDING AND CONSTRUCTION. CONTRACTOR SHALL NOT RELY ON THESE QUANTITIES FOR THEIR BID AND CIVIL ENGINEER IS NOT RESPONSIBLE FOR COST ESTIMATES OR ACTUAL CONSTRUCTION COSTS.

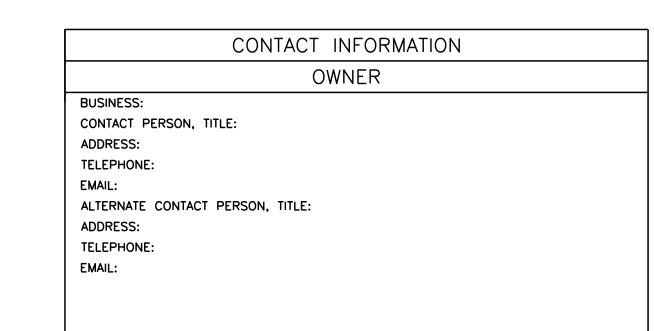

PARTY RESPONSIBLE FOR LONG TERM MAINTENANCE

CONTACT PERSON, TITLE: TELEPHONE: EMAIL:

CONTRACTOR

CONTACT PERSON, TITLE: TELEPHONE: ALTERNATE CONTACT PERSON, TITLE: ADDRESS TELEPHONE: EMAIL:

CONTRACTOR'S ONSITE REPRESENTATIVE

CONTACT PERSON, TITLE: TELEPHONE: ALTERNATE CONTACT: TELEPHONE:

MN STATE DUTY OFFICER 651-649-5457

ALTERNATE: 1-800-422-0798 NOTE: CONTRACTOR'S ONSITE REPRESENTATIVE SHALL BE COMPLETED ON THE PLAN SET KEPT IN THE CONSTRUCTION TRAILER. THIS INFORMATION SHALL ALSO BE PROVIDED TO THE OWNER AND CIVIL ENGINEER.



SITE LOCATION MAP MAP NOT TO SCALE LATITUDE: 45.0599 LONGITUDE: -93.3108

Architecture Interior Design Landscape Architecture Engineering

222 North Second Street Long & Kees Bldg Suite 101 Minneapolis, MN 612.339.3752

www.bkvgroup.com

CONSULTANTS PIERCE PINI & 9298 CENTRAL AVENUE NI SUITE 312 BLAINE, MN 55434 TEL 763.537.1311

PROJECT TITLE

BROOKLYN MULTIFAMIL HOUSING

05/10/2022 | LAND USE APPLICATION 06/14/2022 LAND USE APPLICATION 06/22/2022 REVISION


CERTIFICATION


CHECKED BY COMMISSION NUMBE SHEET TITLE ALATUS -

HOUSING 1 -SWPPP NARRATIVE

MULTIFAMILY

SHEET NUMBER

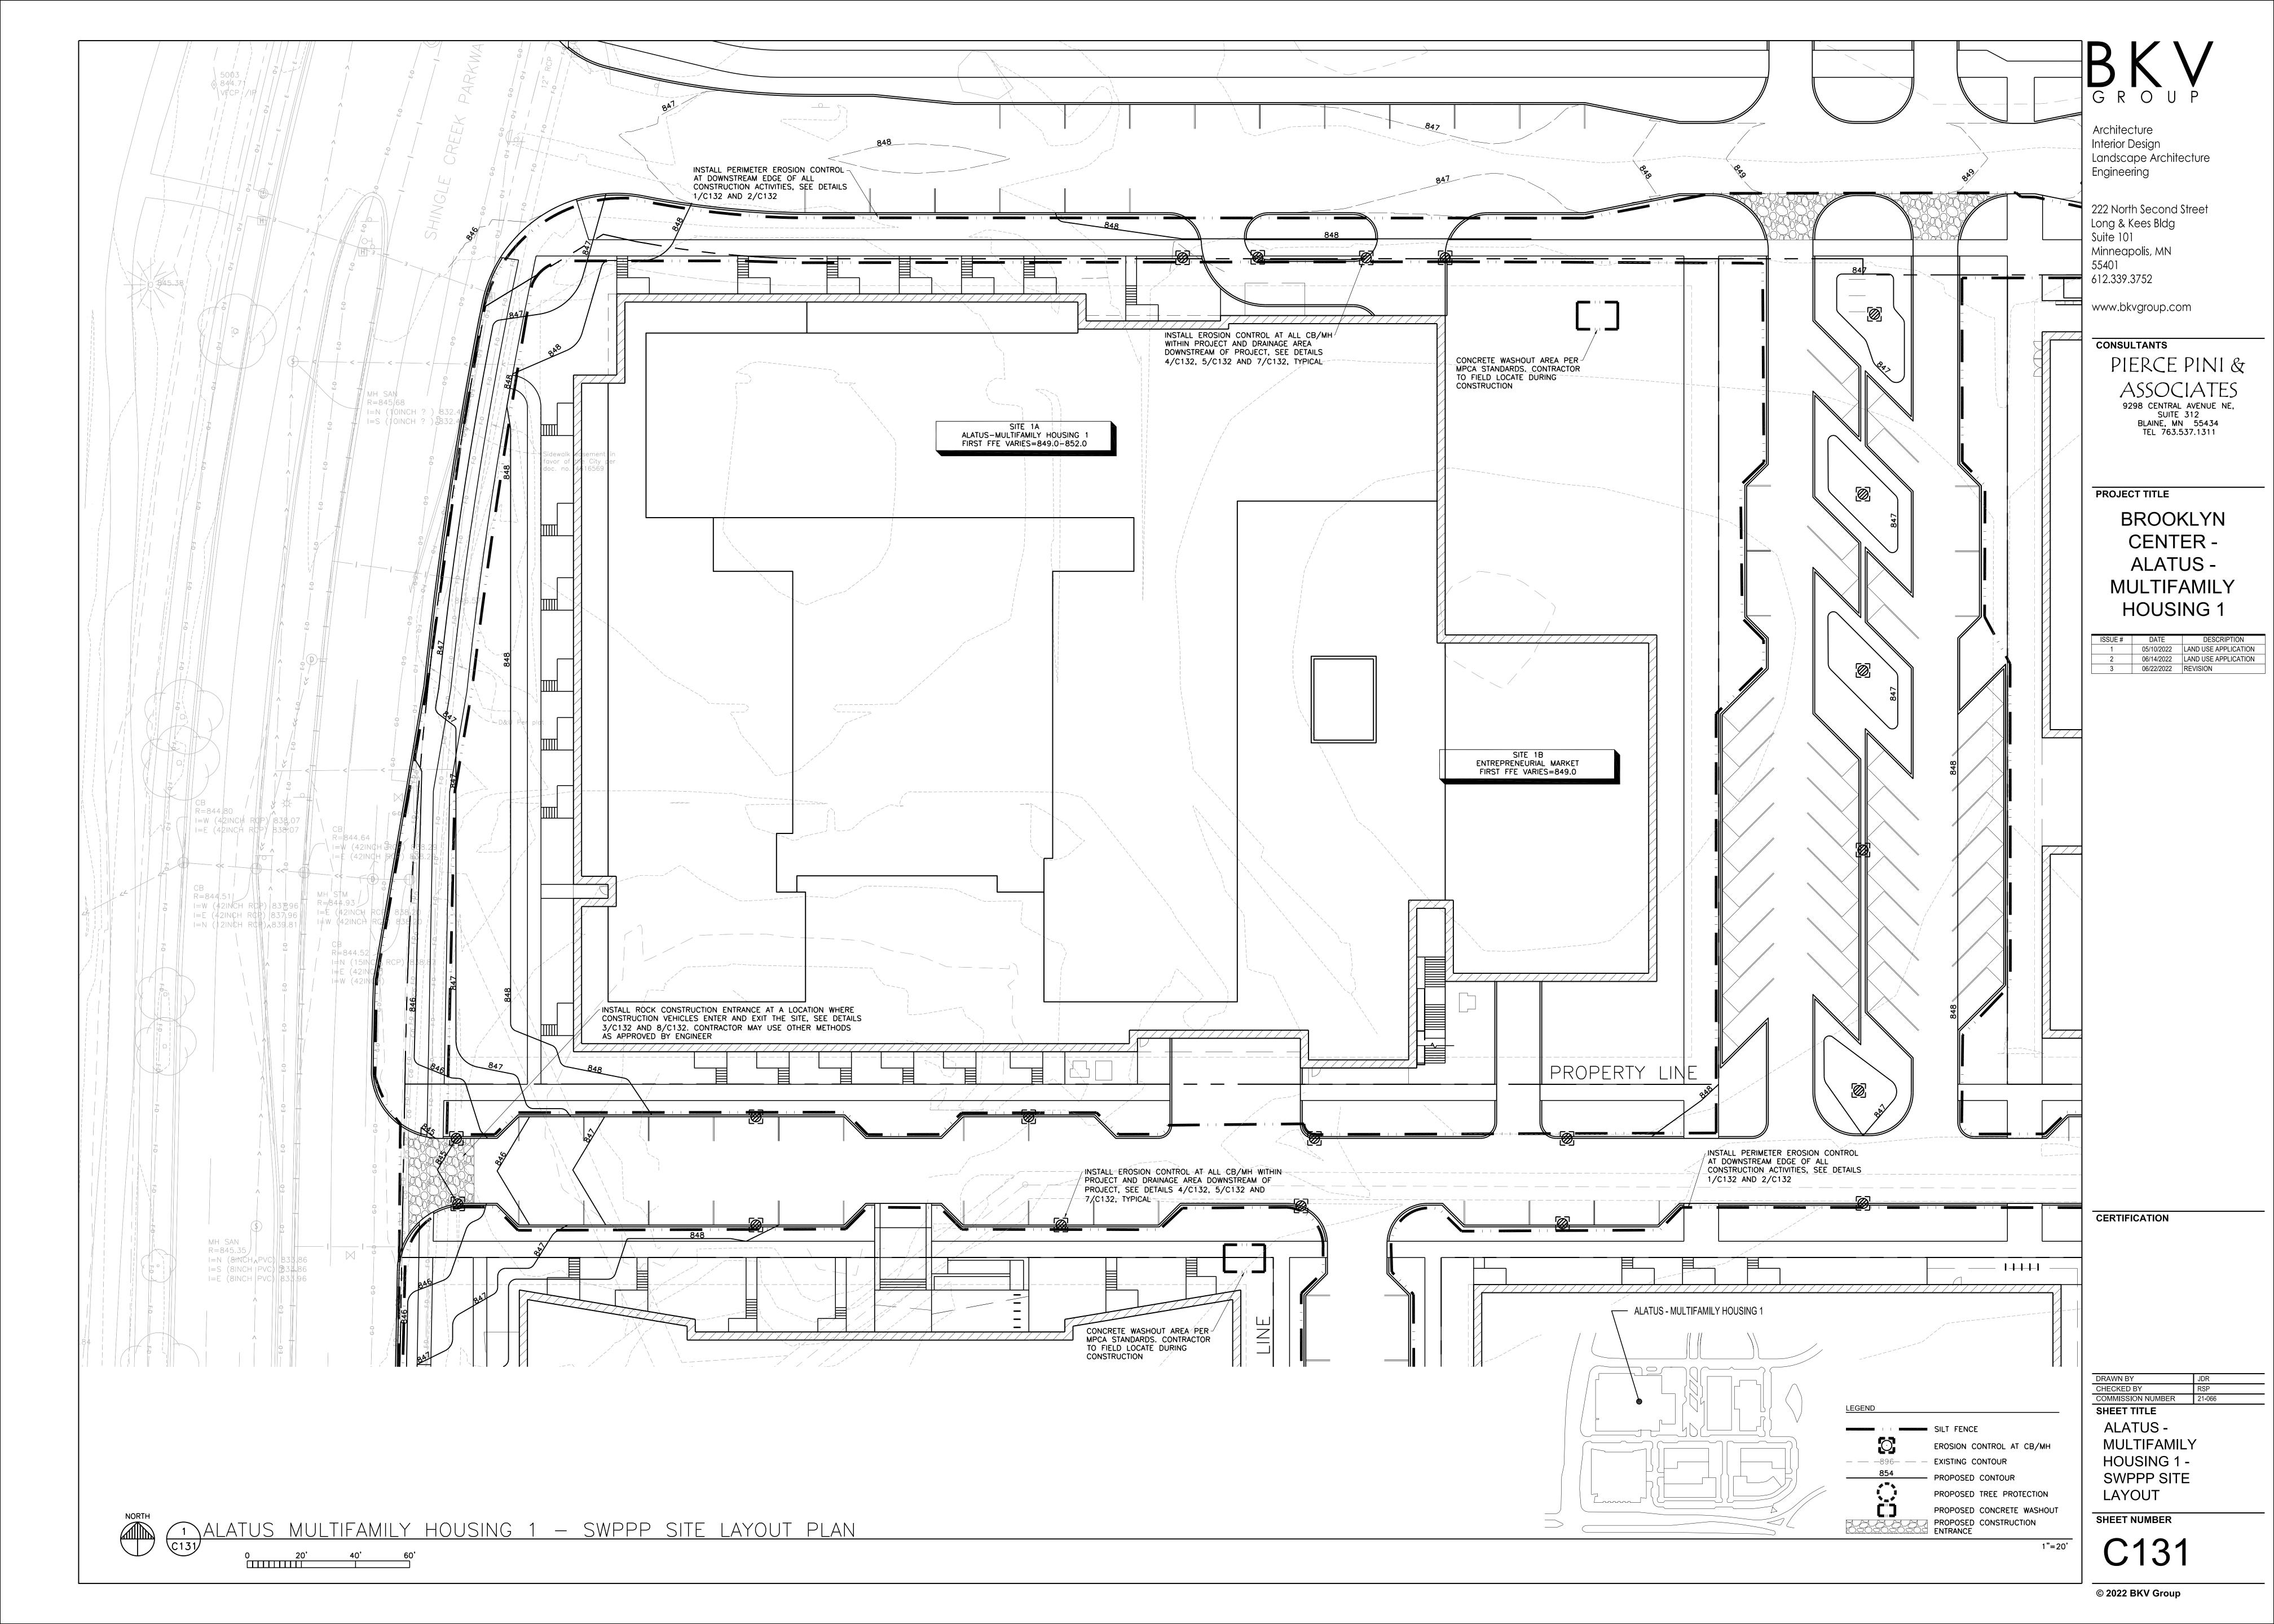

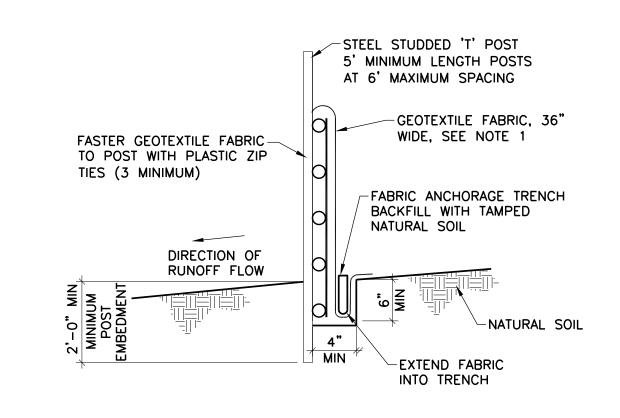


			DESIGN PRACTICES
NOTES: 1. GEOTEXTILE FABRIC SHALL BE PER	SLOPE H:V	PERCENT	MAXIMUM SLOPE LENGTH
MNDOT SPEC 3886.	100:1	1%	100 FT
2. SILT FENCES SHOULD BE INSTALLED ON	50:1	2%	75 FT
THE CONTOUR (AS OPPOSED TO UP AND	25:1	4%	75 FT
DOWN A HILL) AND CONSTRUCTED SO THAT FLOW CANNOT BYPASS THE ENDS.	20:1	5%	75-50 FT
	17:1	6%	50 FT
3. ENSURE DRAINAGE AREA IS NO GREATER	12 5.1	097	50 ET


THAN 1/4 ACRE PER 100 FT OF FENC 4. FIELD VERIFY THE MAXIMUM SLOPE LENGTH IN THE TABLE. THIS LENGTH EQUATES TO A 2 FOOT STORAGE HEIGH FOR THE 100-YEAR EVENT. 5. SILT FENCE INSTALLATION TO CONFORM


TO MNDOT SPEC 2573.3


	SLOPE H:V	PERCENT	MAXIMUM SLOPE LENGTH
	100:1	1%	100 FT
N	50:1	2%	75 FT
AND	25:1	4%	75 FT
S.	20:1	5%	75–50 FT
	17:1	6%	50 FT
ER CE.	12.5:1	8%	50 FT
	10:1	10%	50-25 FT
	5:1	20%	25-15 FT
HT	4:1	25%	15 FT
	3:1	33%	15 FT
M	2:1	50%	15 FT

BY ACCEPTED

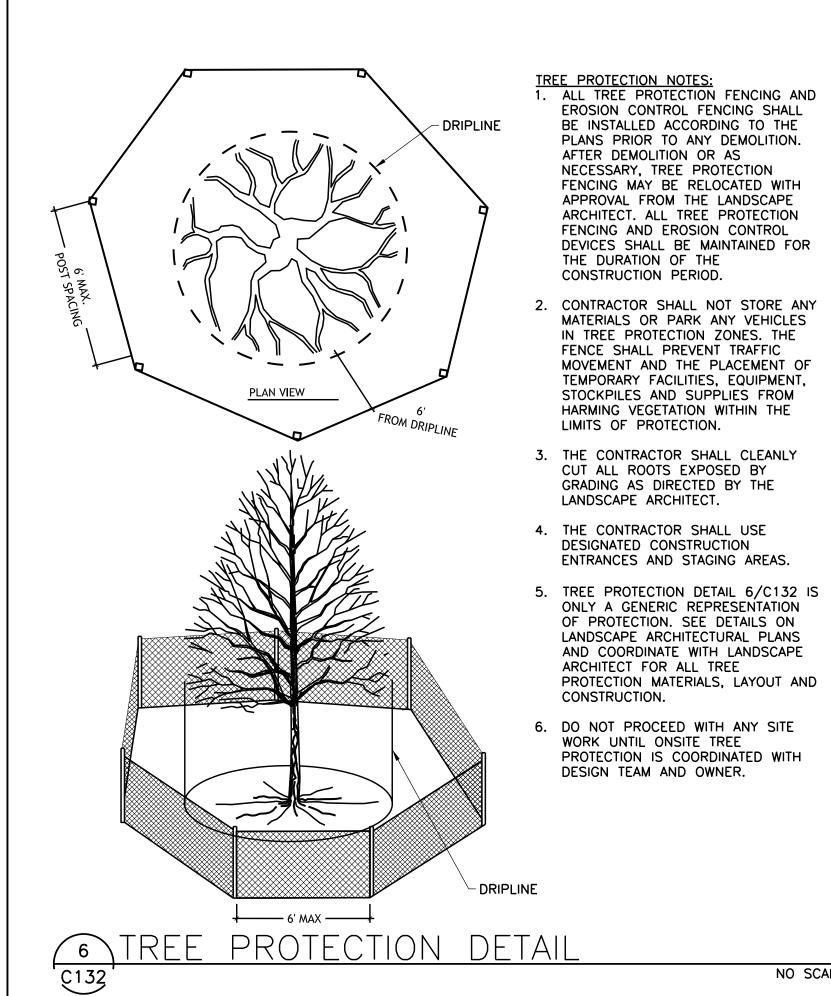


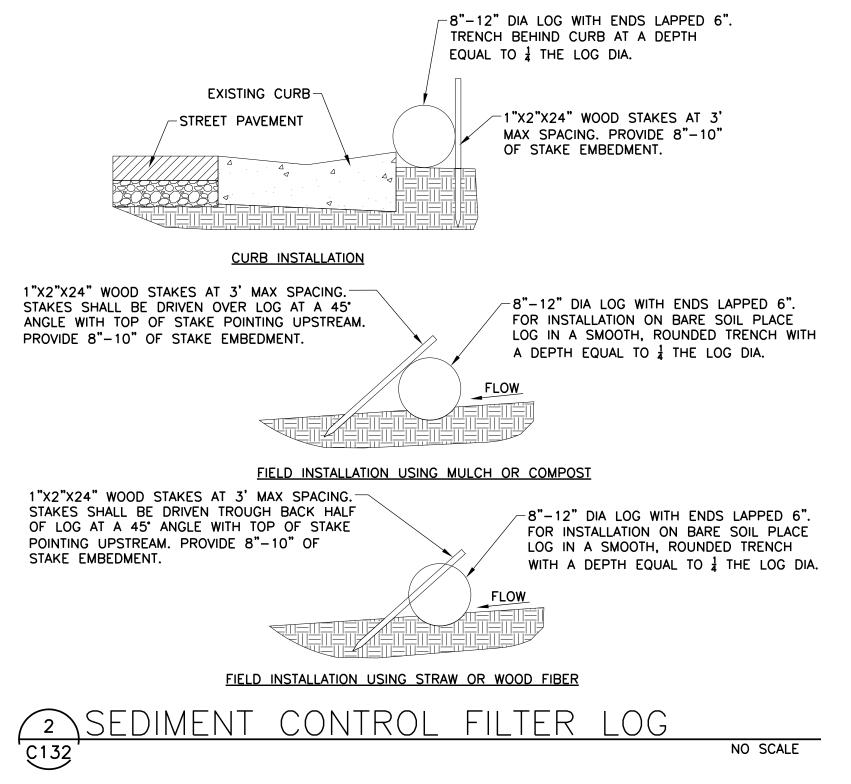


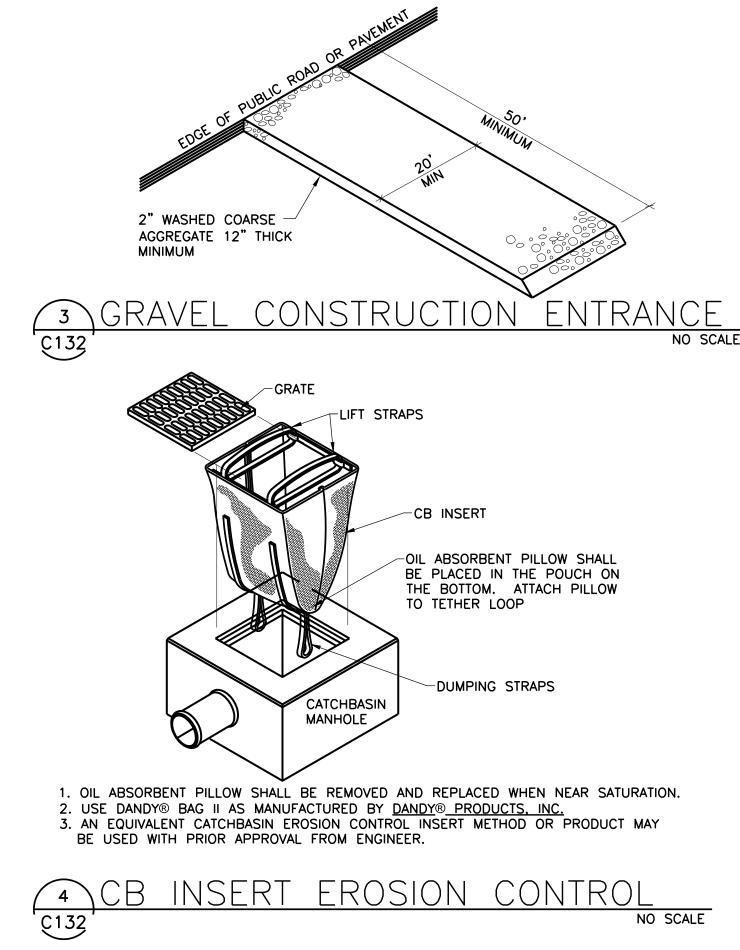

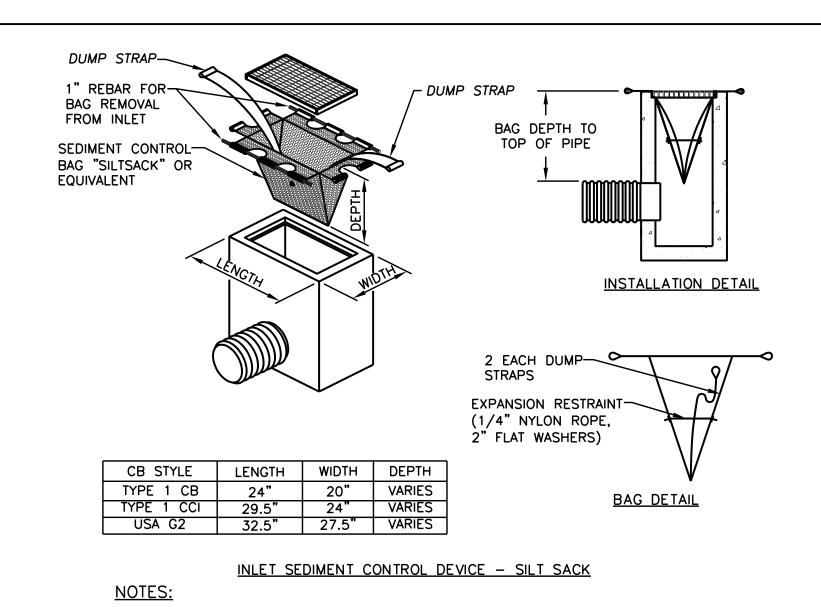


- 1. THE DIMENSION CHART ABOVE IS FOR STANDARD CATCH BASINS AND INLETS ONLY. THE CONTRACTOR IS RESPONSIBLE FOR PROVIDING THE CORRECT SIZE DEVICE FOR EACH INLET.
- 2. FOR NON-STANDARD CATCH BASINS AND INLETS, THE CONTRACTOR SHALL MEASURE DIMENSIONS IN THE FIELD AND ORDER THE APPROPRIATE SIZE(S).
- 3. THE INLET SEDIMENT CONTROL DEVICE SHALL BE OF HIGH FLOW DESIGN (200 GAL/MIN/FT), AS PER THE MANUFACTURER'S SPECS.
- 4. THE SEDIMENT CONTROL DEVICE SHALL BE INSPECTED DAILY BY THE CONTRACTOR AND MAINTAINED A MINIMUM ONCE PER MONTH OR WITHIN THE 48 HOURS FOLLOWING A STORM EVENT. FILTER SHALL BE CLEANED IN A MANNER WHICH ENSURES THAT ALL SEDIMENT REMAINS
- 5. SUBSTITUTION OF A SHEET OF FILTER FABRIC PLACED OVER THE OPENING OF THE INLET IS NOT APPROVED.
- 6. RECESSED CURB INLET CATCH BASINS MUST BE BLOCKED WHEN USING FILTER FABRIC INLET SACKS, SIZE OF FILTER INLET SACK TO BE DETERMINED BY MANUFACTURER.
- 7. THE FILTER SHALL BE REPLACED OR CLEANED WHEN THE BAG BECOMES HALF FULL.

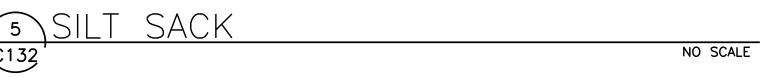

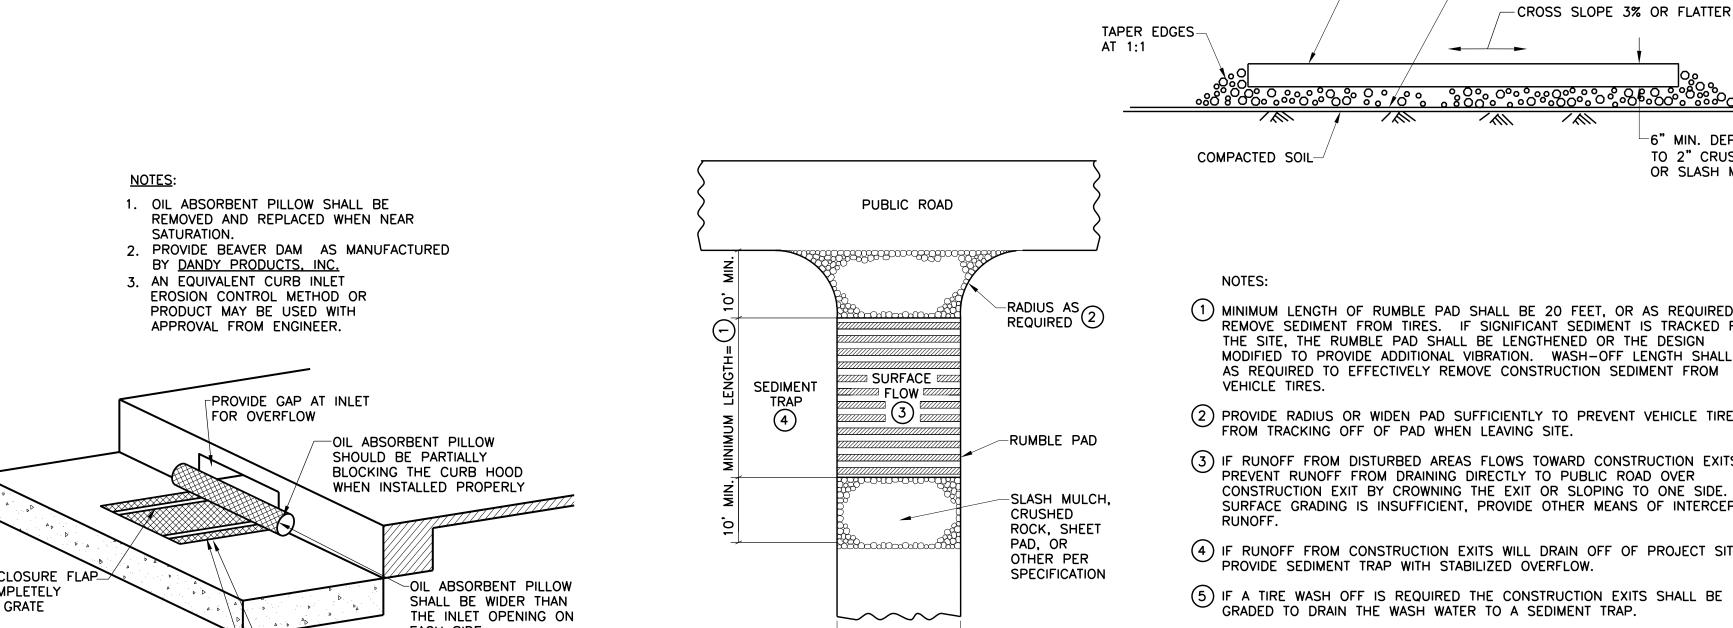



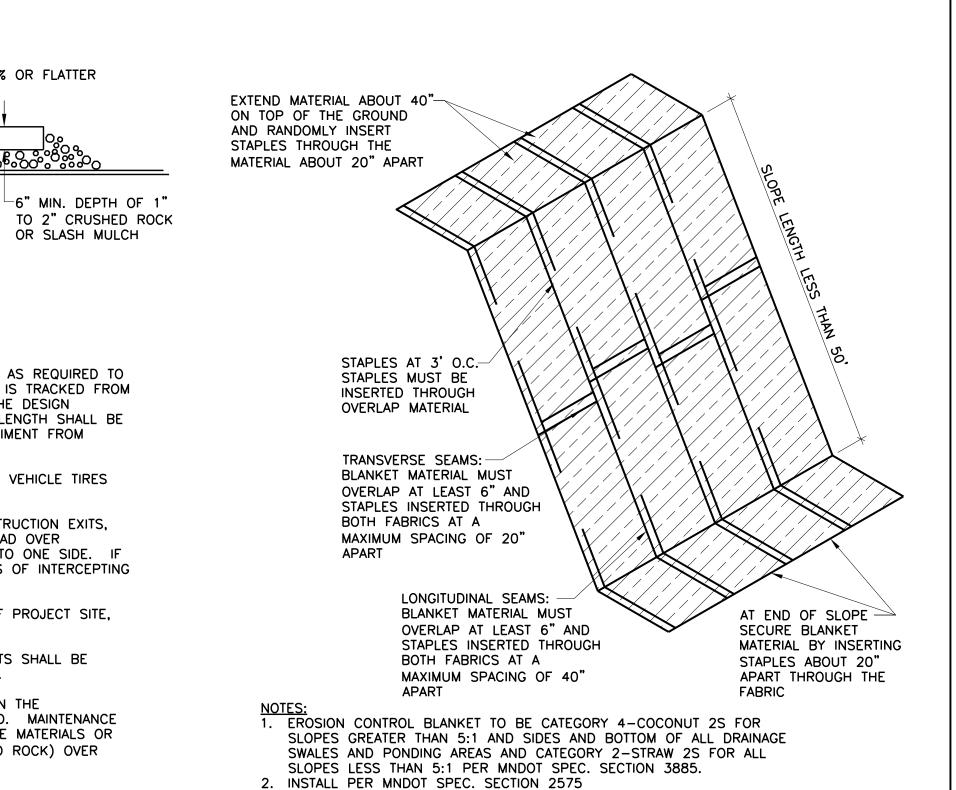

9 EROSION CONTROL BLANKET

Architecture Interior Design Landscape Architecture

> 222 North Second Street Long & Kees Bldg Suite 101 Minneapolis, MN

> > 612.339.3752

Engineering

www.bkvgroup.com

CONSULTANTS PIERCE PINI & 9298 CENTRAL AVENUE NE, SUITE 312 BLAINE, MN 55434

TEL 763.537.1311

PROJECT TITLE

BROOKLYN **CENTER-**ALATUS -**MULTIFAMILY** HOUSING '

05/10/2022 LAND USE APPLICATION 06/14/2022 LAND USE APPLICATION 06/22/2022 REVISION


CERTIFICATION

NO SCALE

SHEET TITLE ALATUS -**MULTIFAMILY** HOUSING 1 -SWPPP DETAILS

SHEET NUMBER

© 2022 BKV Group

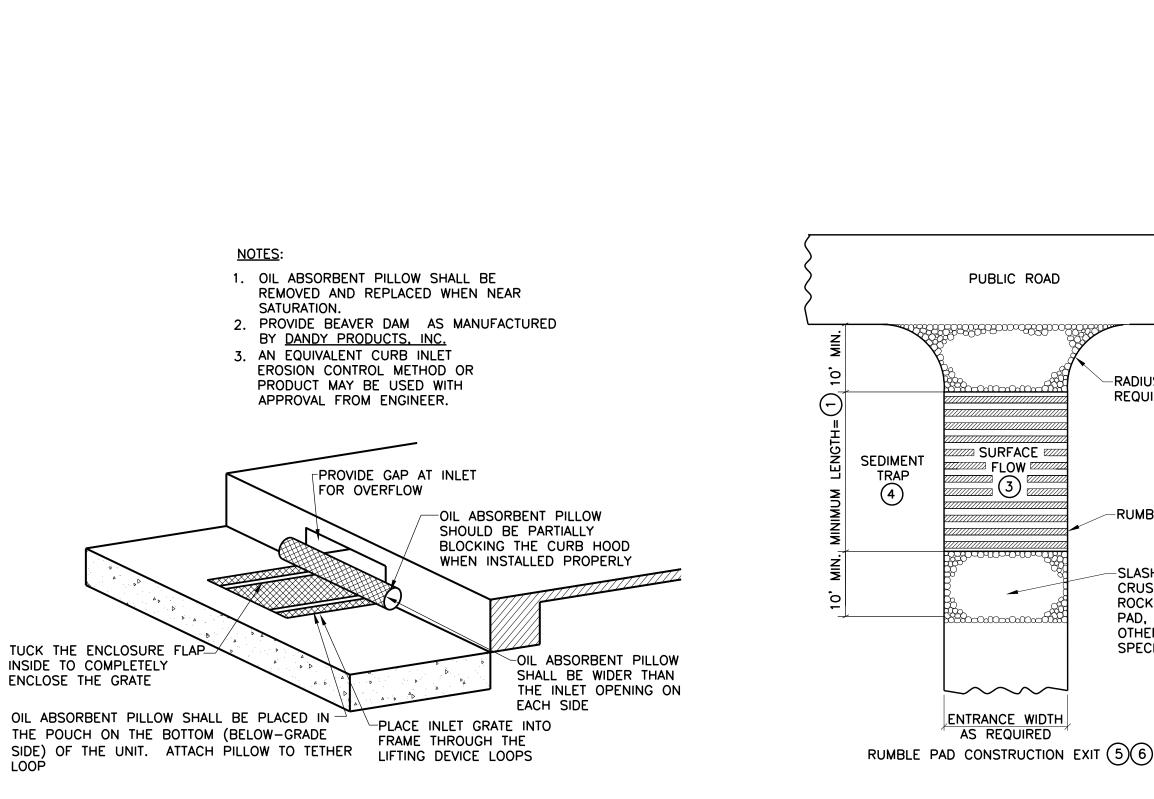

CATCHBASIN CURB BOX INLET

©132 EROSION CONTROL

(1) MINIMUM LENGTH OF RUMBLE PAD SHALL BE 20 FEET, OR AS REQUIRED TO REMOVE SEDIMENT FROM TIRES. IF SIGNIFICANT SEDIMENT IS TRACKED FROM THE SITE, THE RUMBLE PAD SHALL BE LENGTHENED OR THE DESIGN MODIFIED TO PROVIDE ADDITIONAL VIBRATION. WASH-OFF LENGTH SHALL BE AS REQUIRED TO EFFECTIVELY REMOVE CONSTRUCTION SEDIMENT FROM 2 PROVIDE RADIUS OR WIDEN PAD SUFFICIENTLY TO PREVENT VEHICLE TIRES FROM TRACKING OFF OF PAD WHEN LEAVING SITE. (3) IF RUNOFF FROM DISTURBED AREAS FLOWS TOWARD CONSTRUCTION EXITS, PREVENT RUNOFF FROM DRAINING DIRECTLY TO PUBLIC ROAD OVER CONSTRUCTION EXIT BY CROWNING THE EXIT OR SLOPING TO ONE SIDE. IF

ENTRANCE WIDTH AS REQUIRED

SURFACE GRADING IS INSUFFICIENT, PROVIDE OTHER MEANS OF INTERCEPTING (4) IF RUNOFF FROM CONSTRUCTION EXITS WILL DRAIN OFF OF PROJECT SITE, PROVIDE SEDIMENT TRAP WITH STABILIZED OVERFLOW. 5) IF A TIRE WASH OFF IS REQUIRED THE CONSTRUCTION EXITS SHALL BE GRADED TO DRAIN THE WASH WATER TO A SEDIMENT TRAP. 6 MAINTENANCE OF CONSTRUCTION EXITS SHALL OCCUR WHEN THE


- CORRUGATED STEEL PANELS

-GEOTEXTILE FABRIC

- CROSS SLOPE 3% OR FLATTER


NO SCALE


ÉFFECTIVENESS OF SEDIMENT REMOVAL HAS BEEN REDUCED. MAINTENANCE SHALL CONSIST OF REMOVING SEDIMENT AND CLEANING THE MATERIALS OR PLACING ADDITIONAL MATERIAL (SLASH MULCH OR CRUSHED ROCK) OVER SEDIMENT FILLED MATERIAL TO RESTORE EFFECTIVENESS.

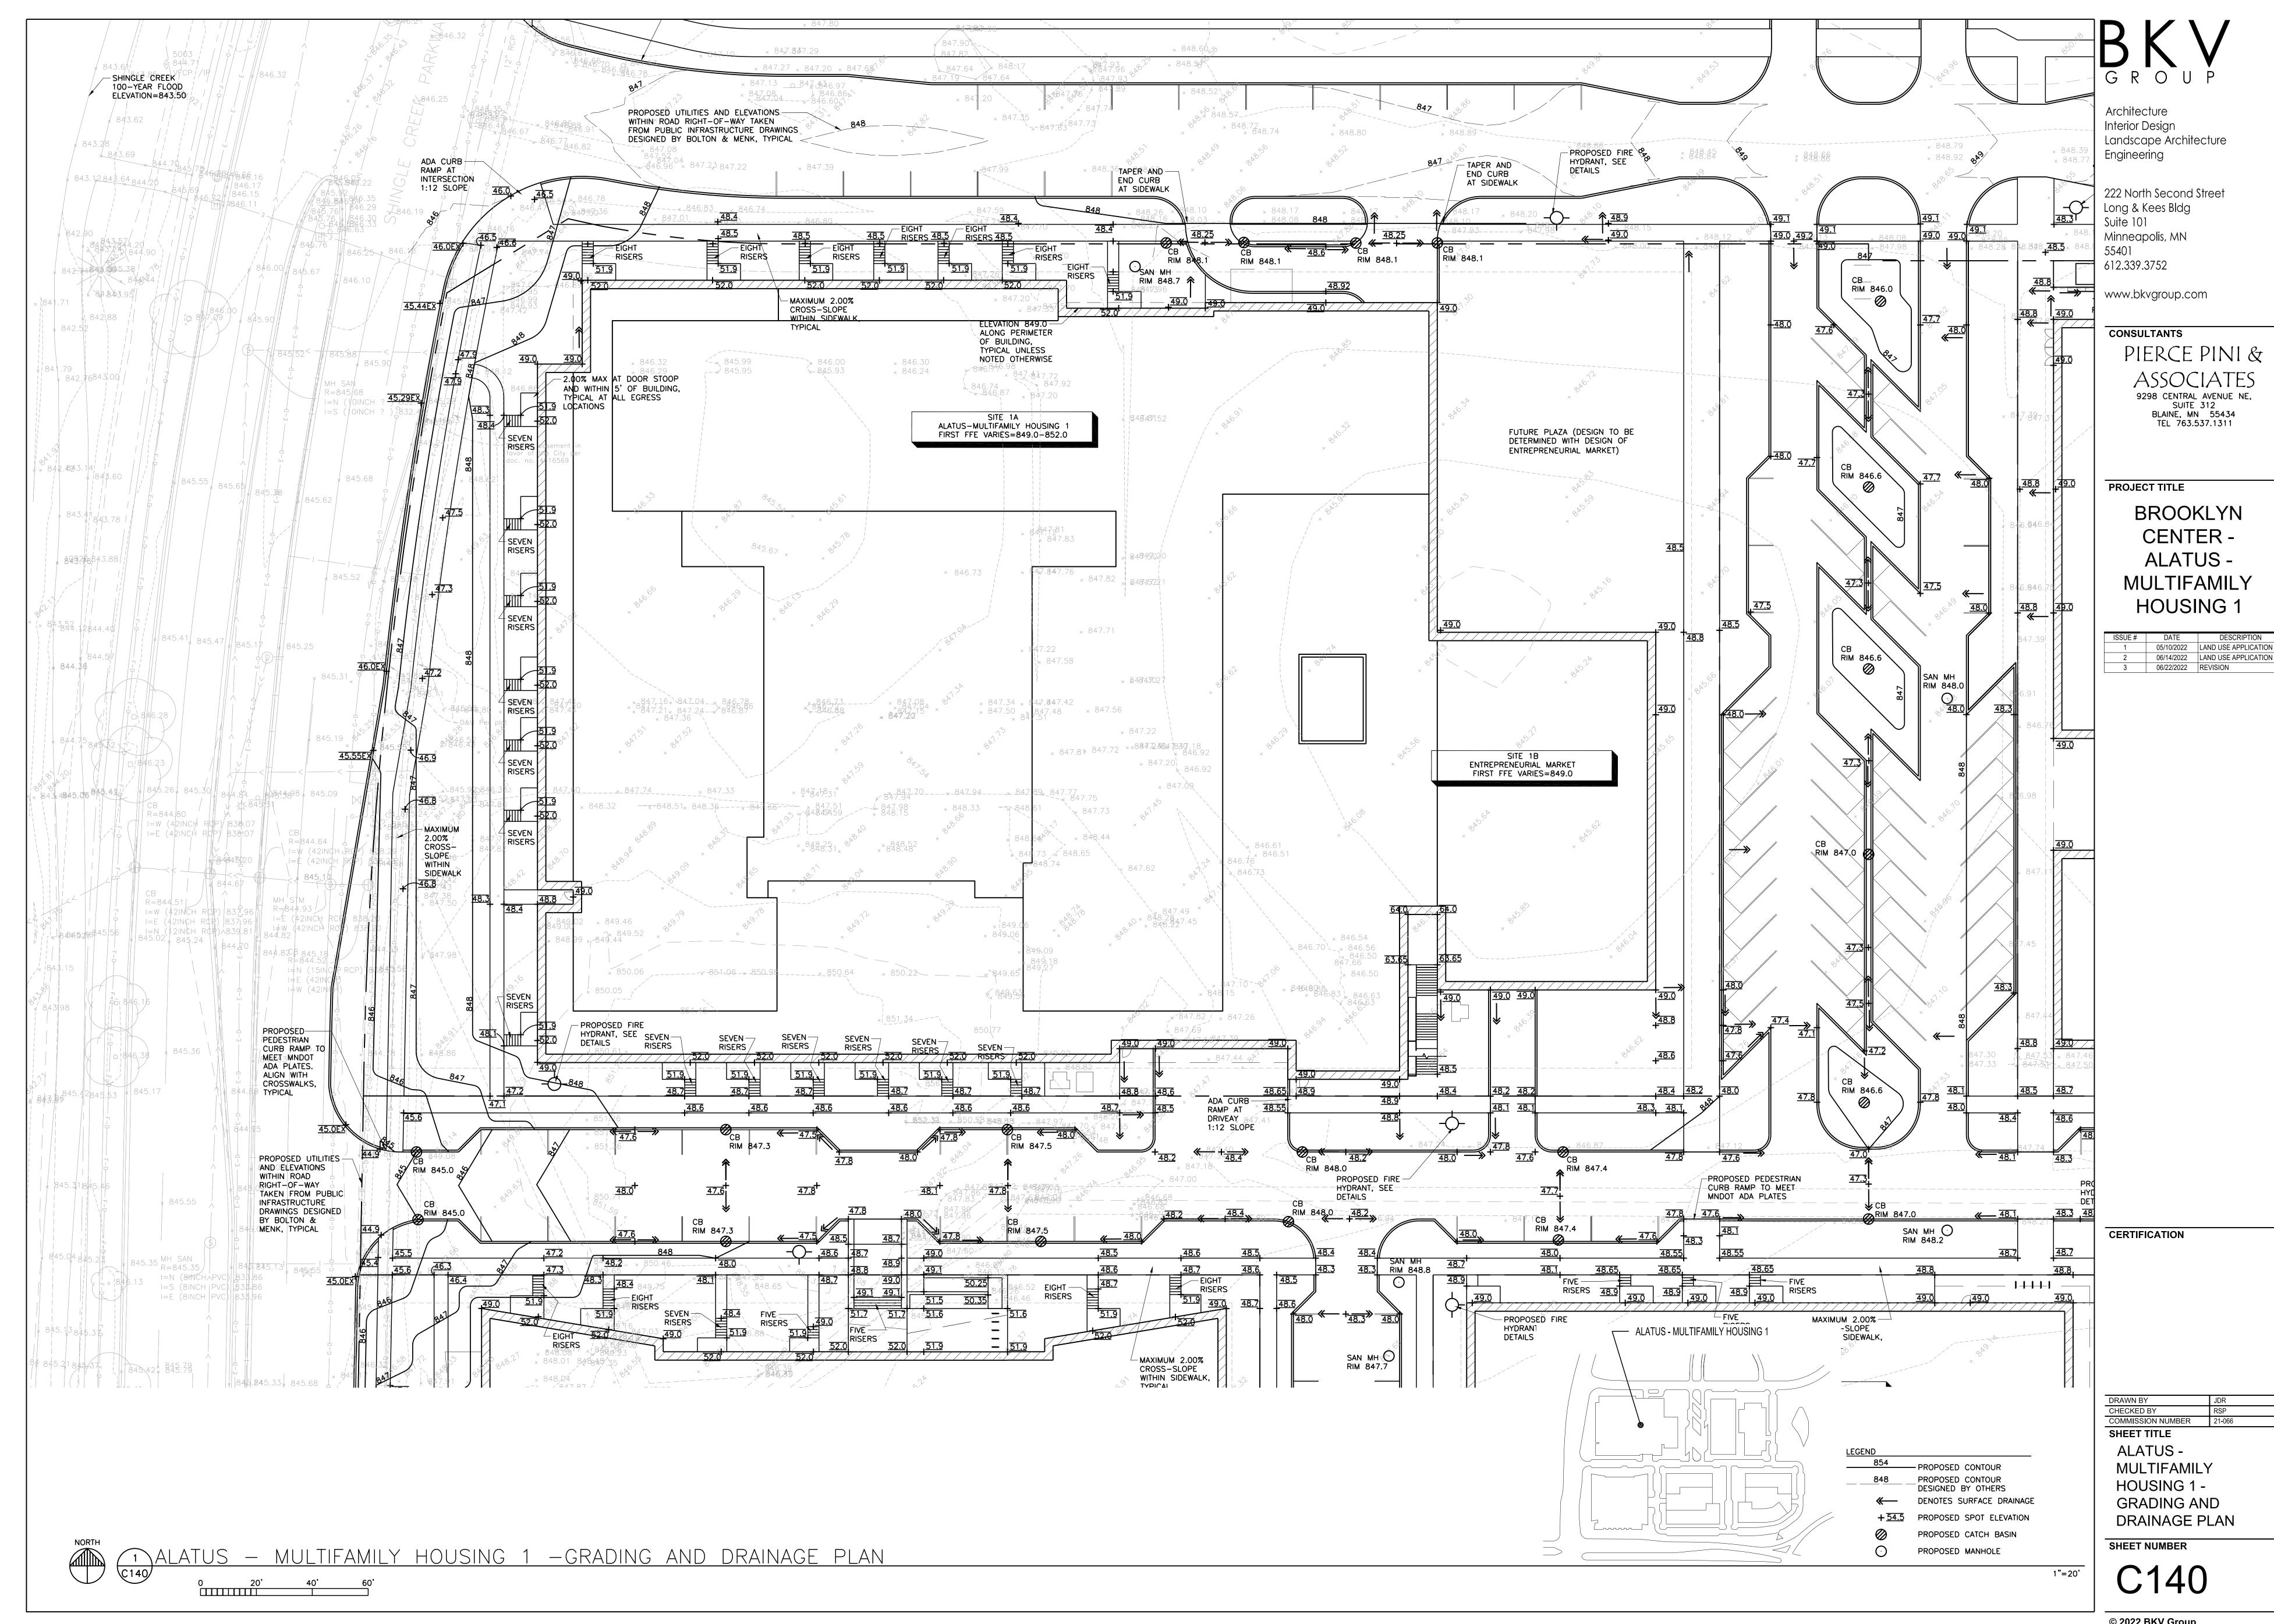



© 2022 BKV Group


05/10/2022 LAND USE APPLICATION 06/14/2022 LAND USE APPLICATION

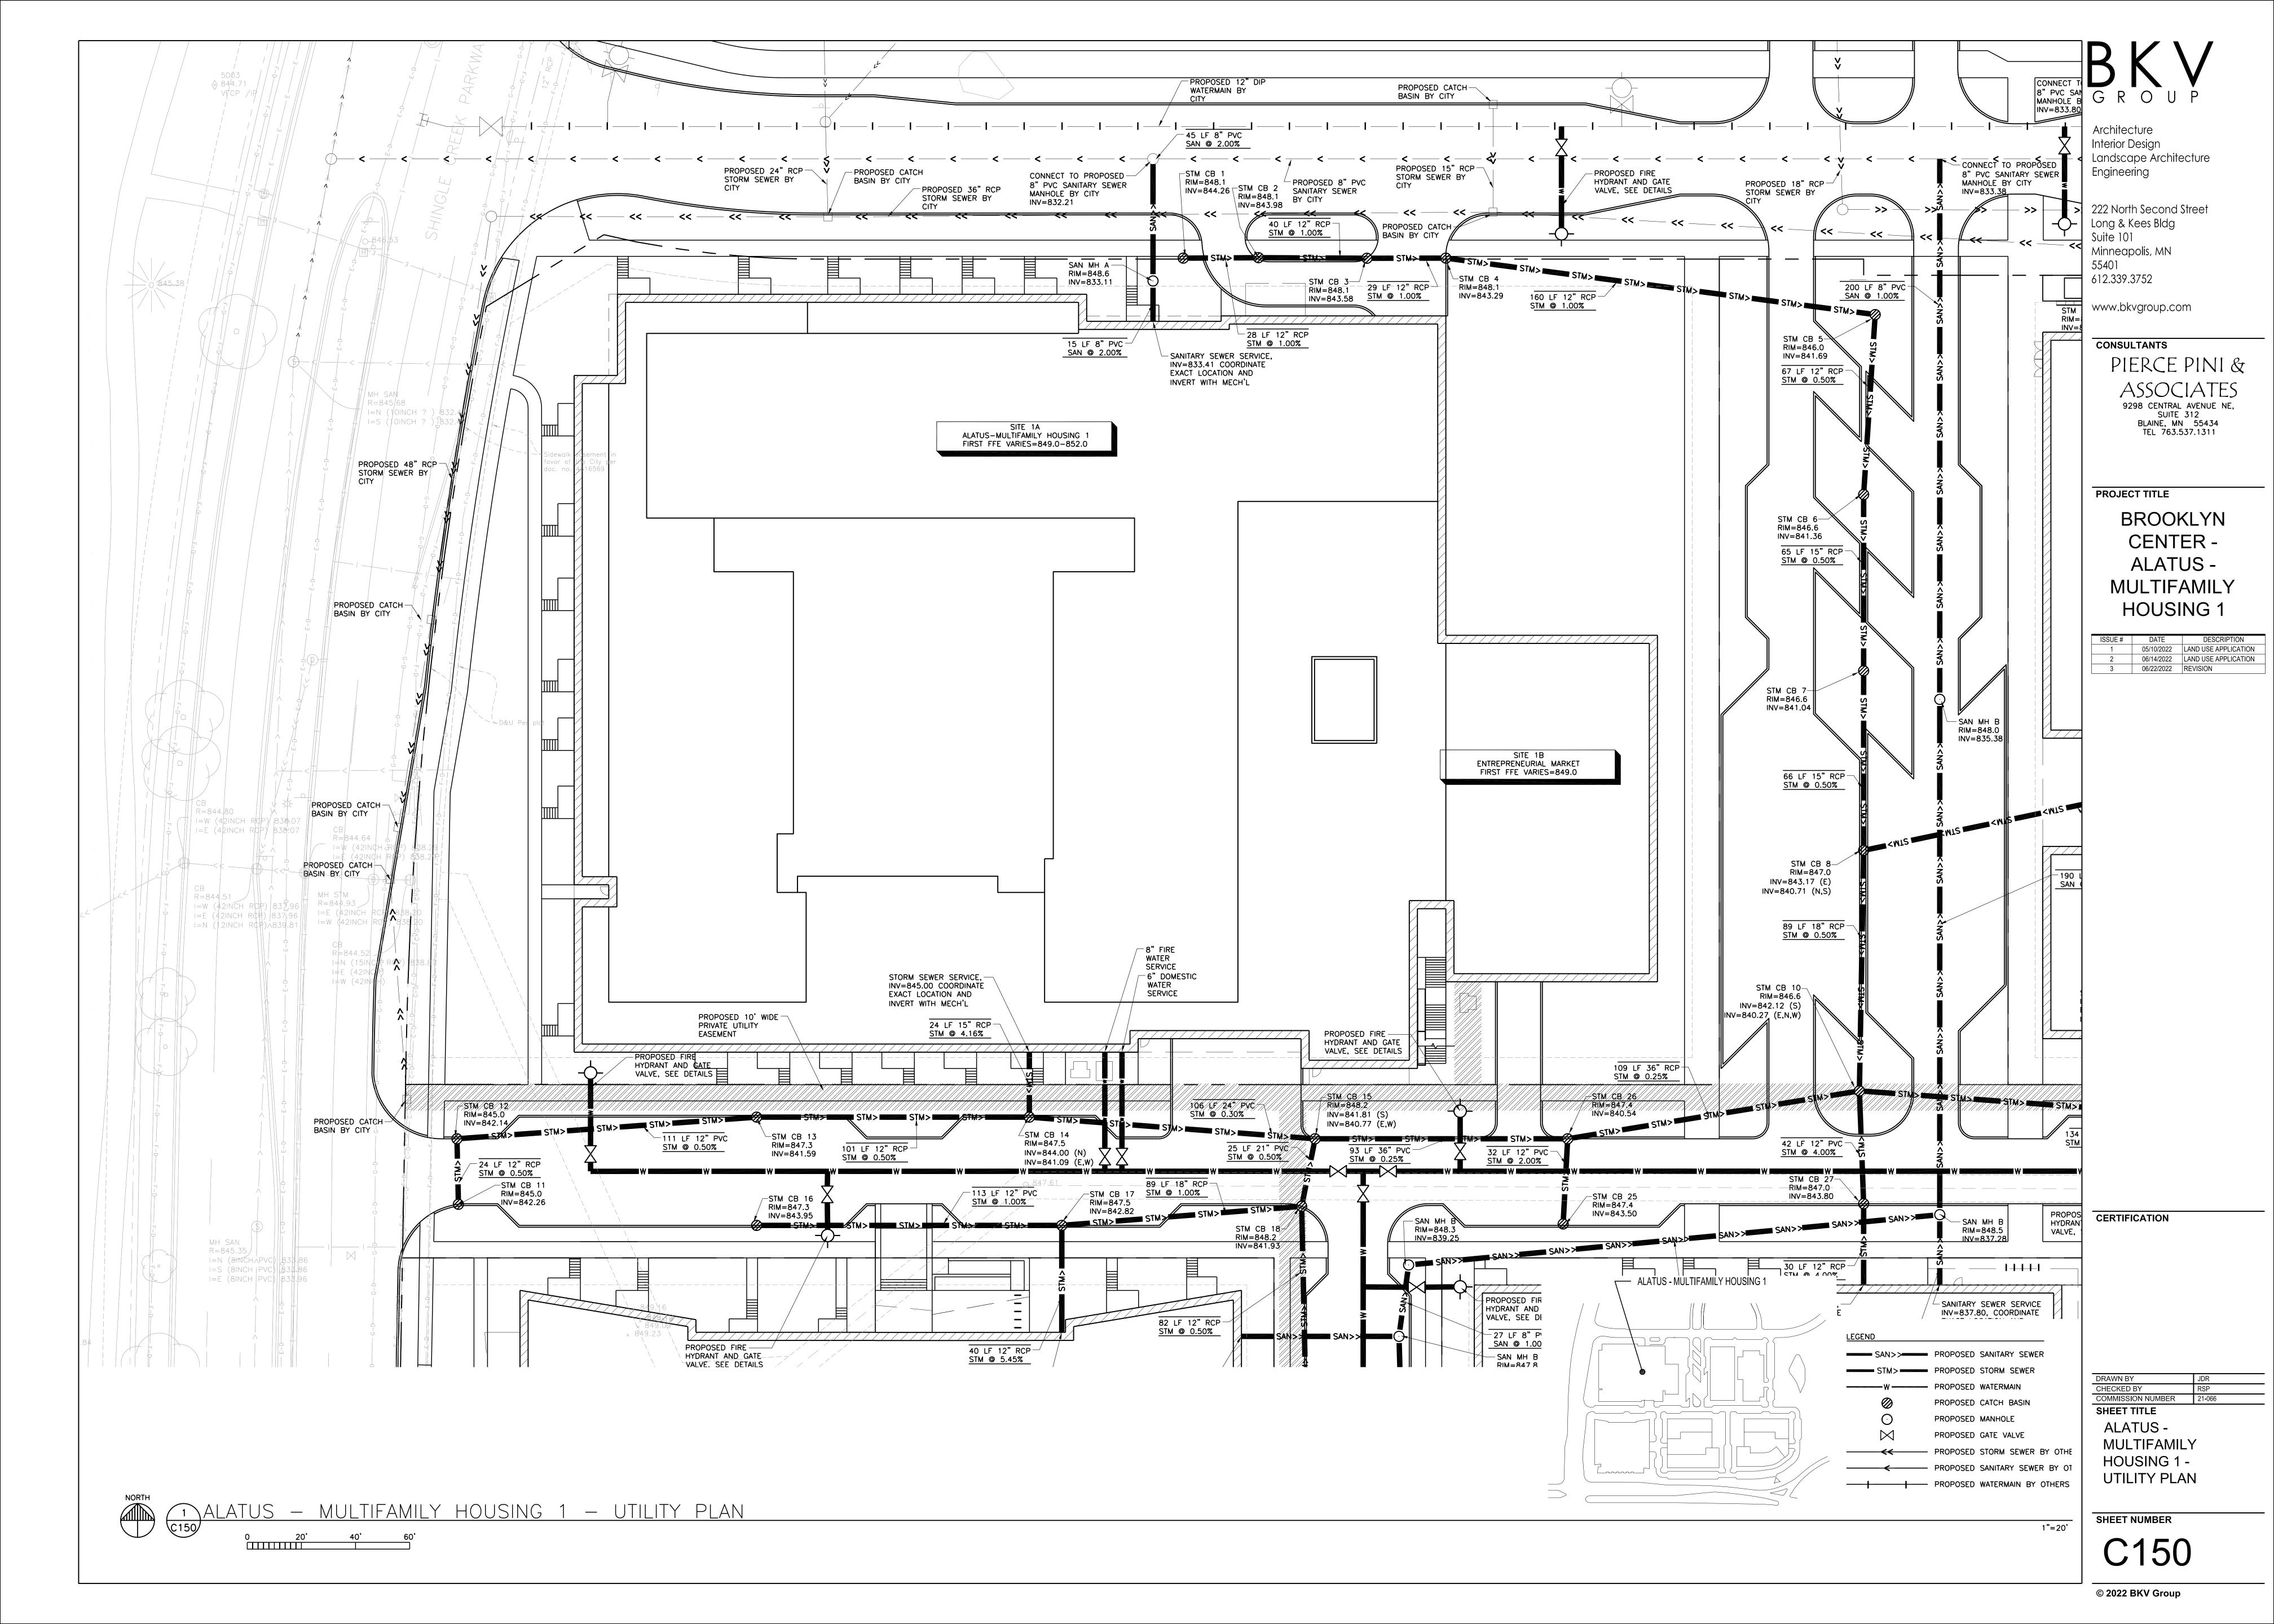


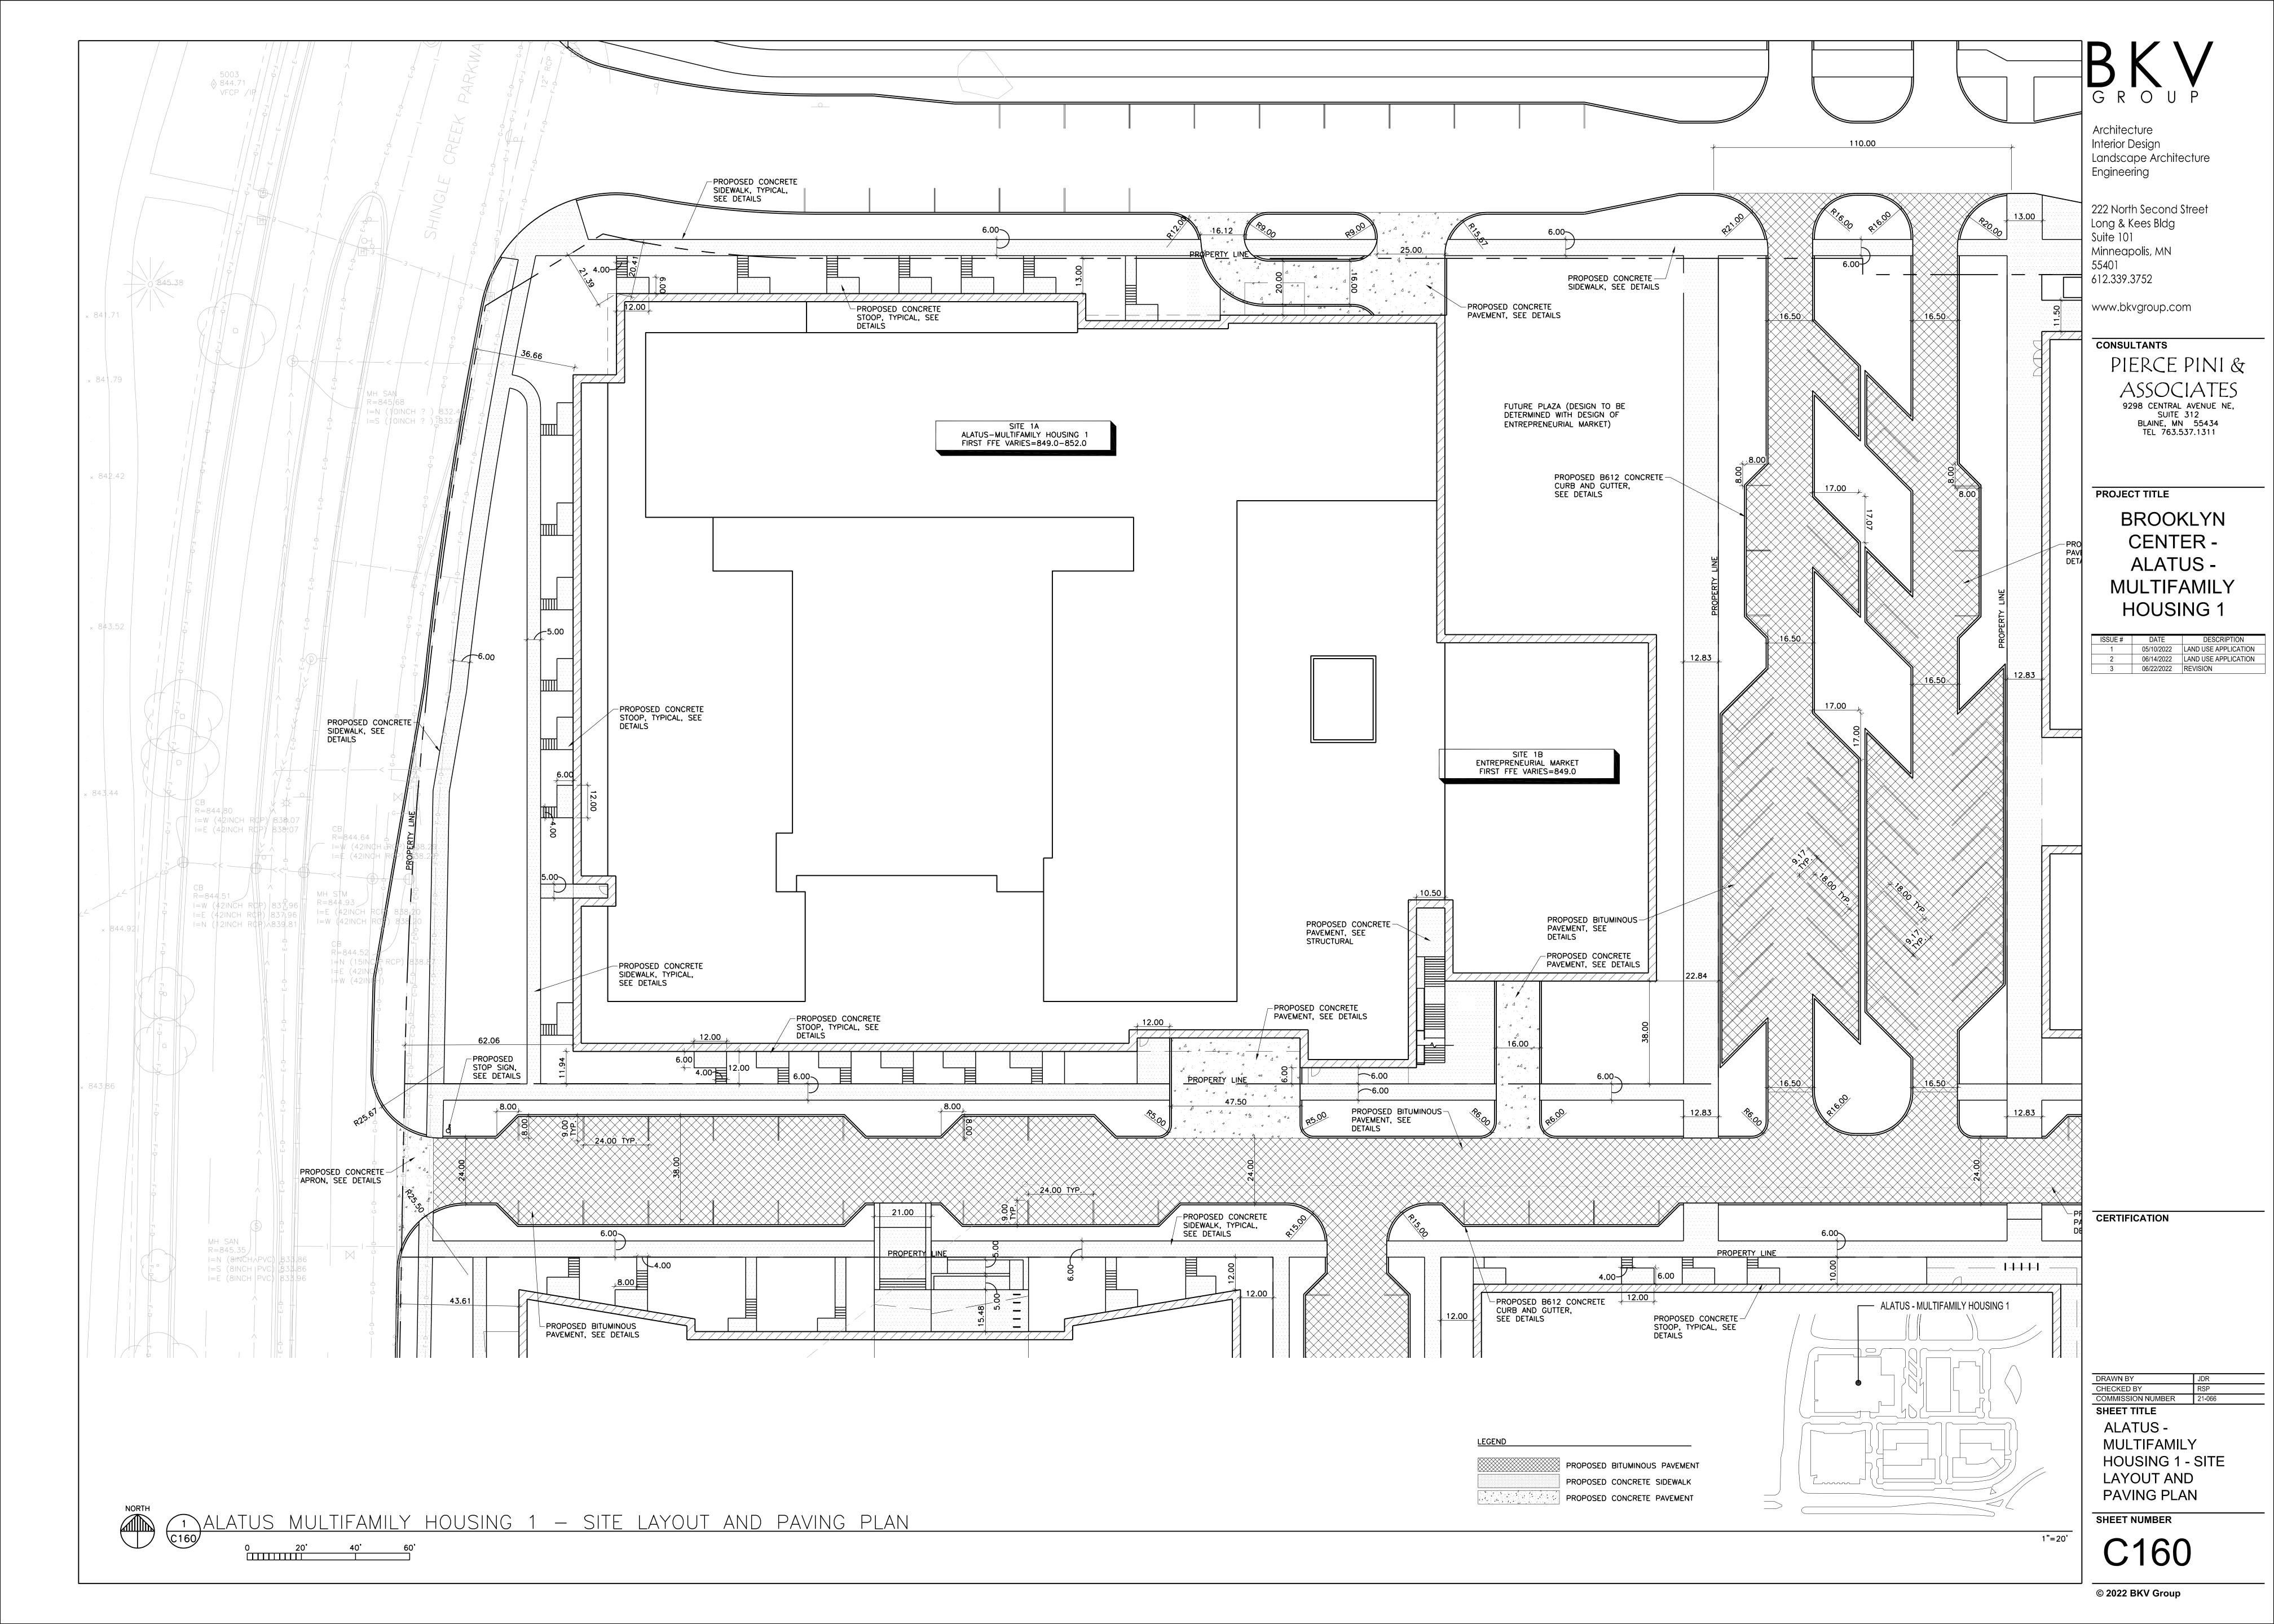


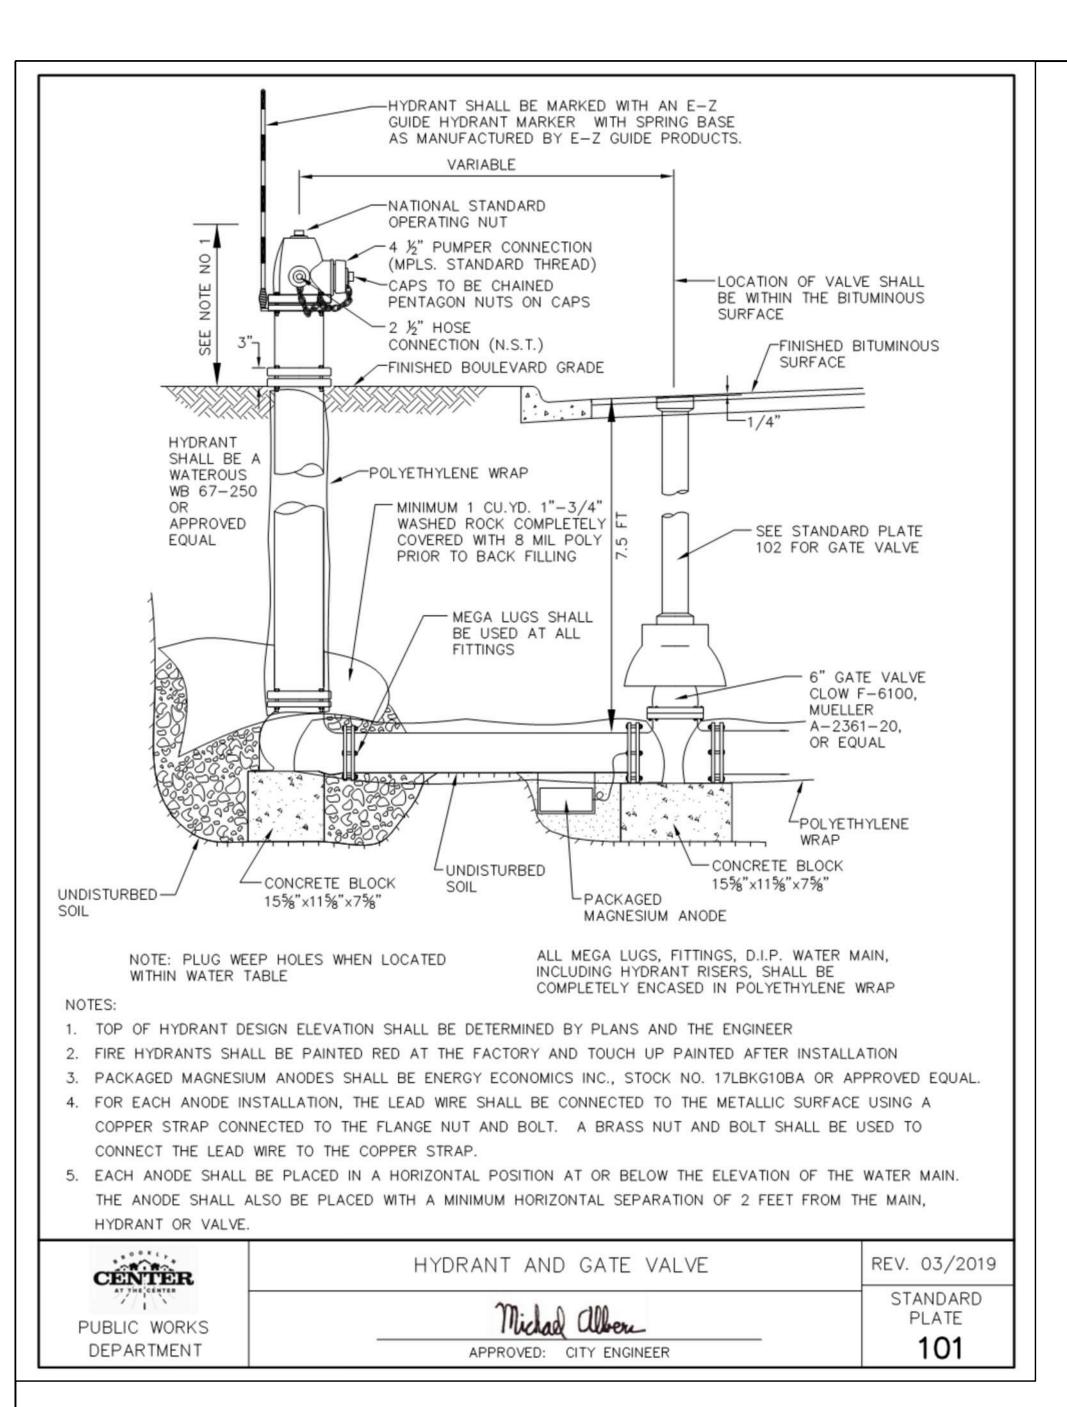

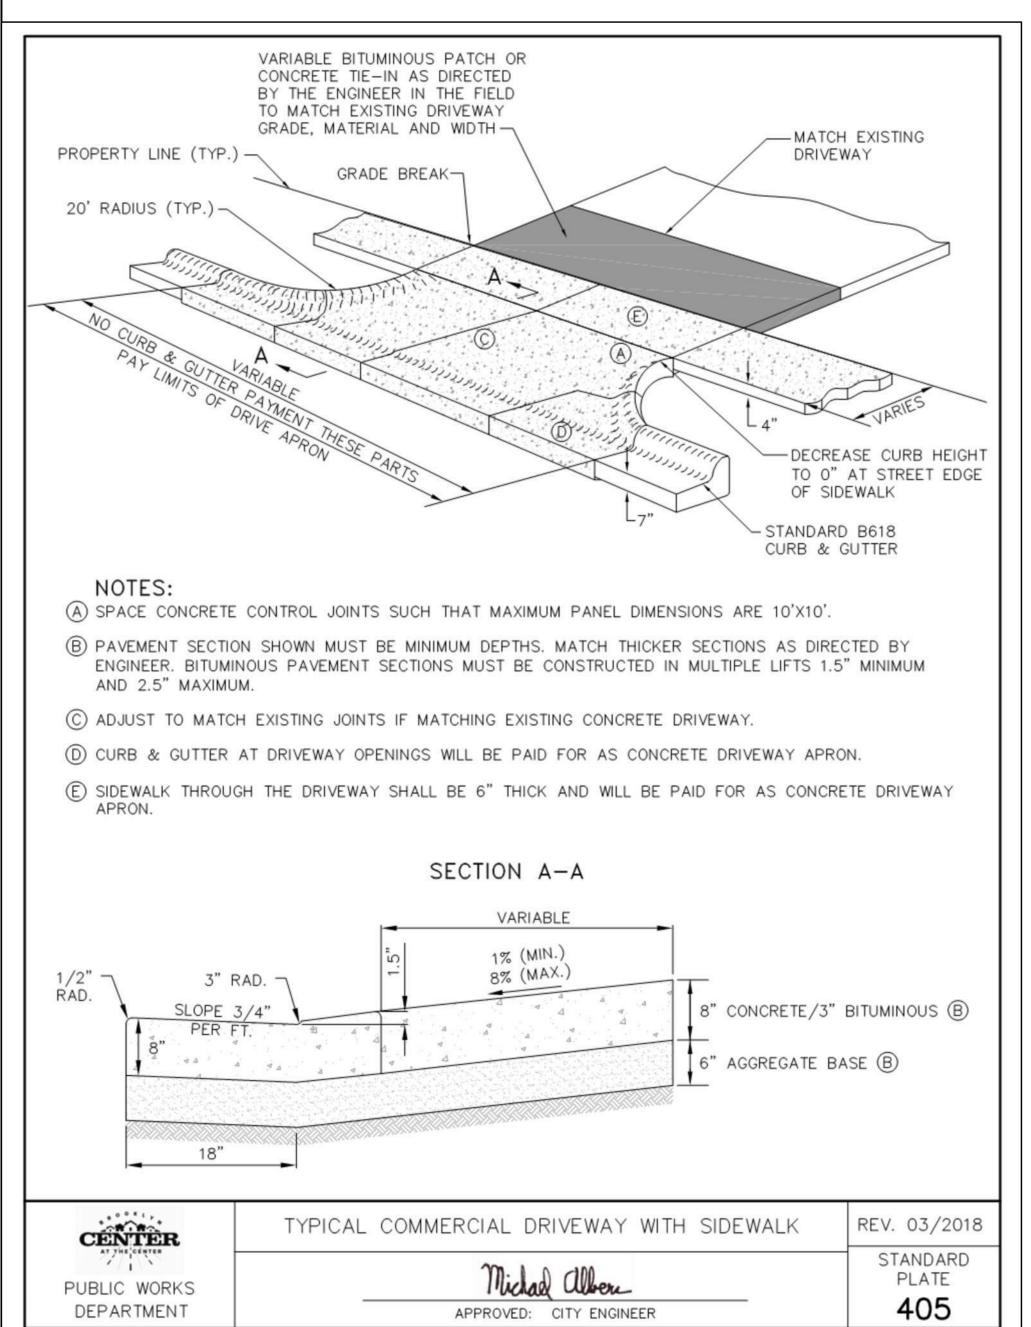

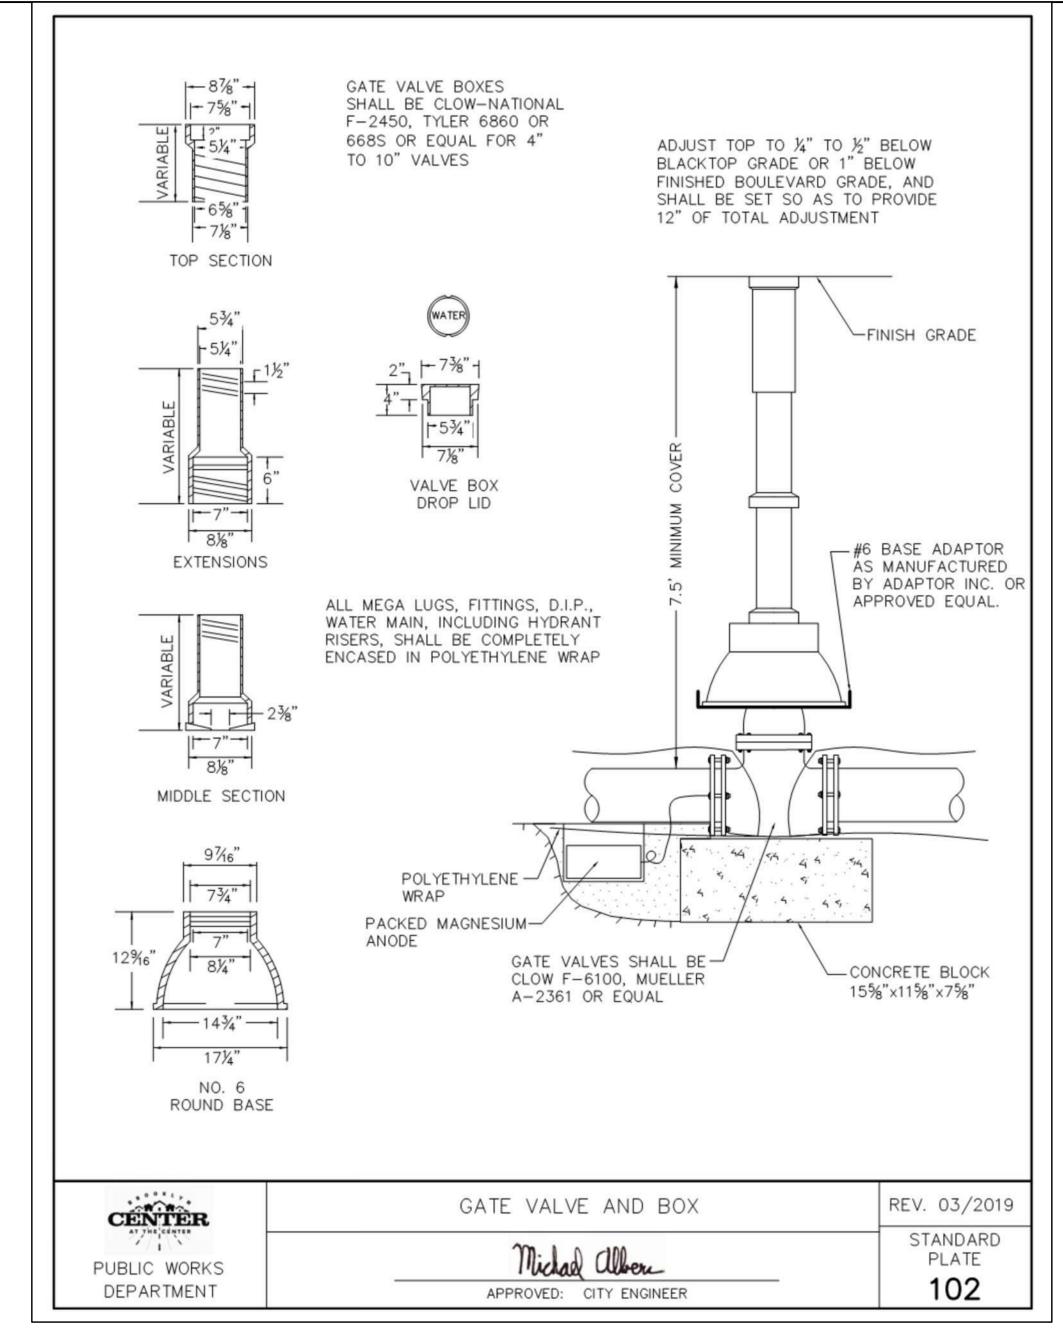

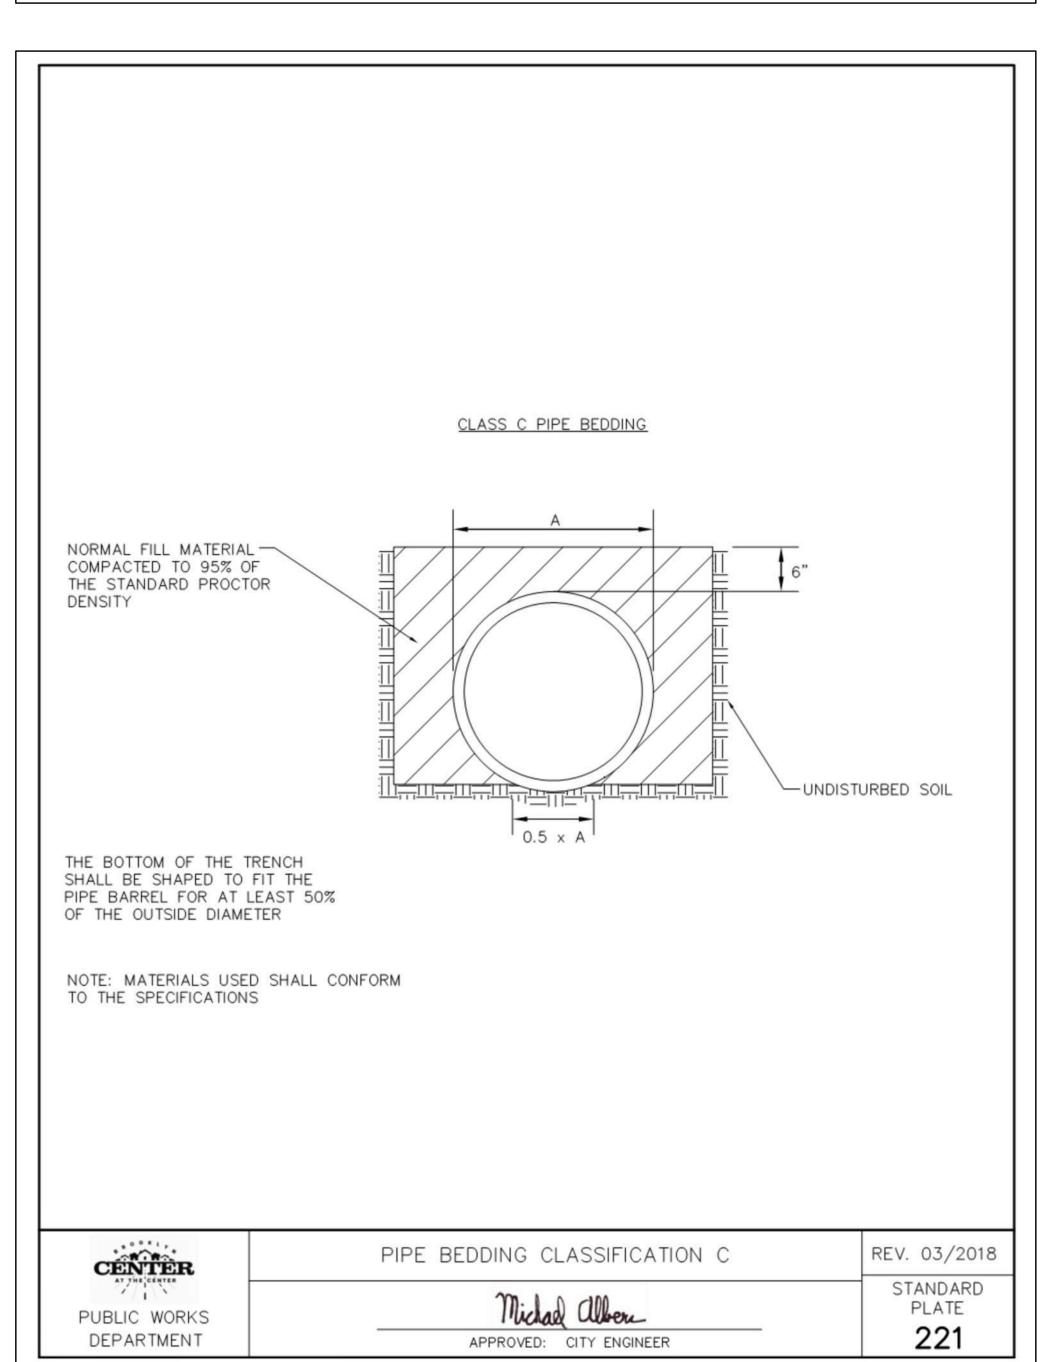

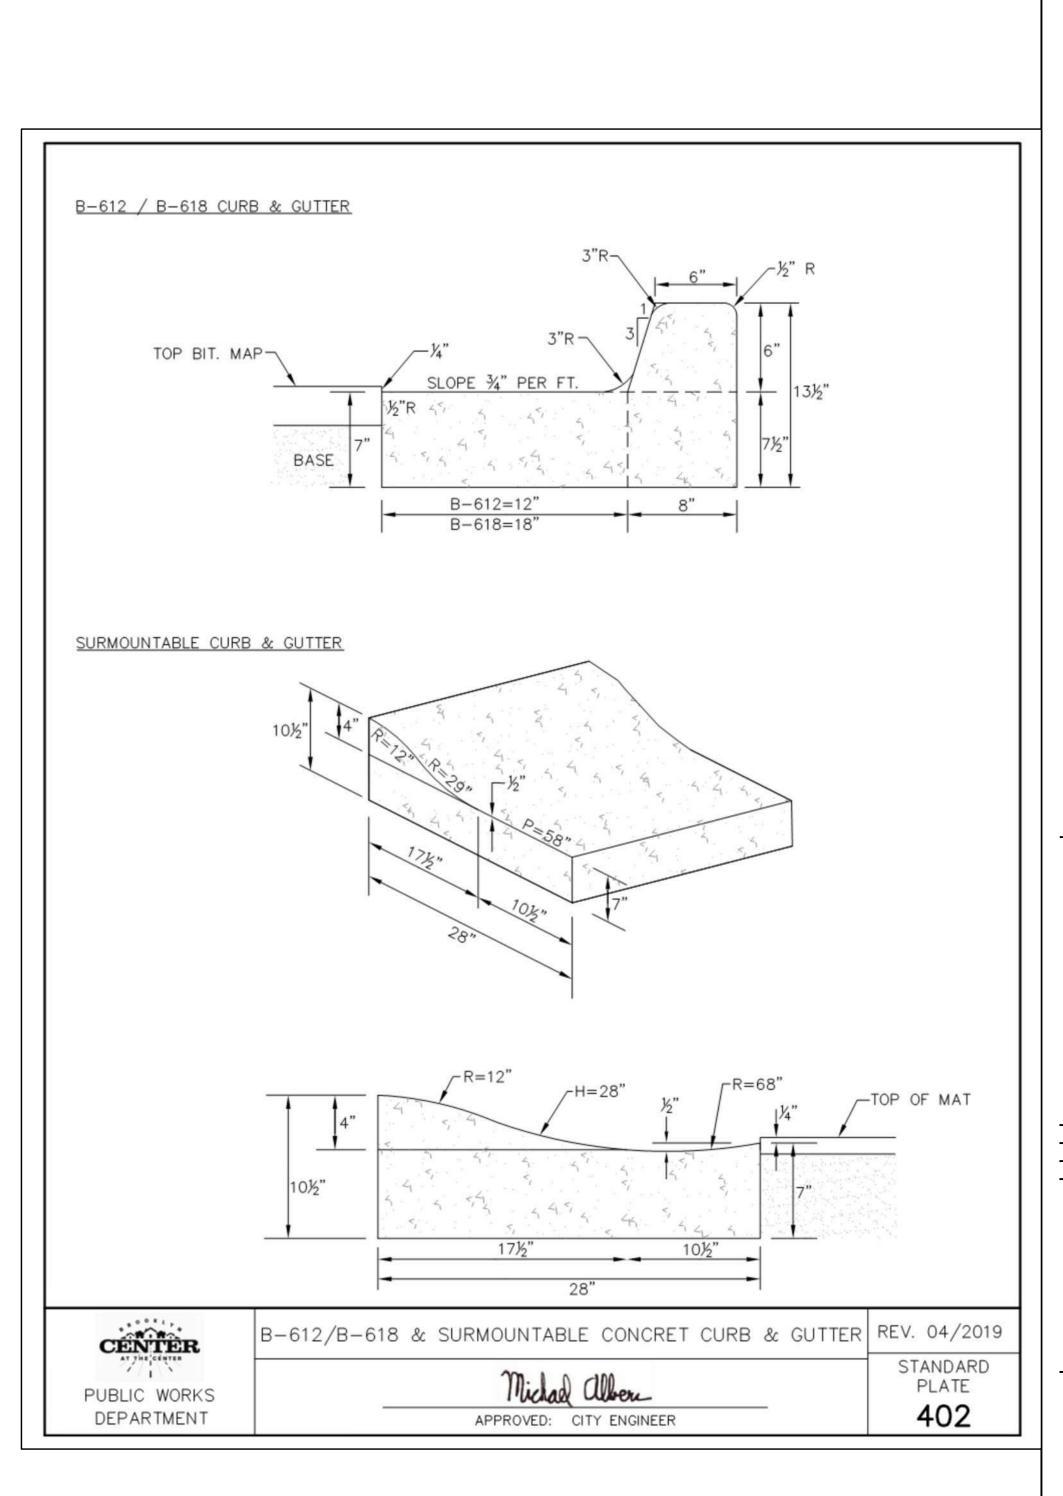



Architecture
Interior Design
Landscape Architecture
Engineering

222 North Second Street Long & Kees Bldg Suite 101 Minneapolis, MN 55401 612.339.3752

www.bkvgroup.com

CONSULTANTS

PIERCE PINI &

ASSOCIATES

9298 CENTRAL AVENUE NE,
SUITE 312
BLAINE, MN 55434

TEL 763.537.1311

PROJECT TITLE

BROOKLYN
CENTER ALATUS MULTIFAMILY
HOUSING 1

| ISSUE # DATE | DESCRIPTION | 1 | 05/10/2022 | LAND USE APPLICATION | 2 | 06/14/2022 | LAND USE APPLICATION | 3 | 06/22/2022 | REVISION |


CERTIFICATION

DRAWN BY
CHECKED BY
COMMISSION NUMBER
21-066

SHEET TITLE
ALATUS MULTIFAMILY
HOUSING 1 - CITY
DETAILS

SHEET NUMBER

C170

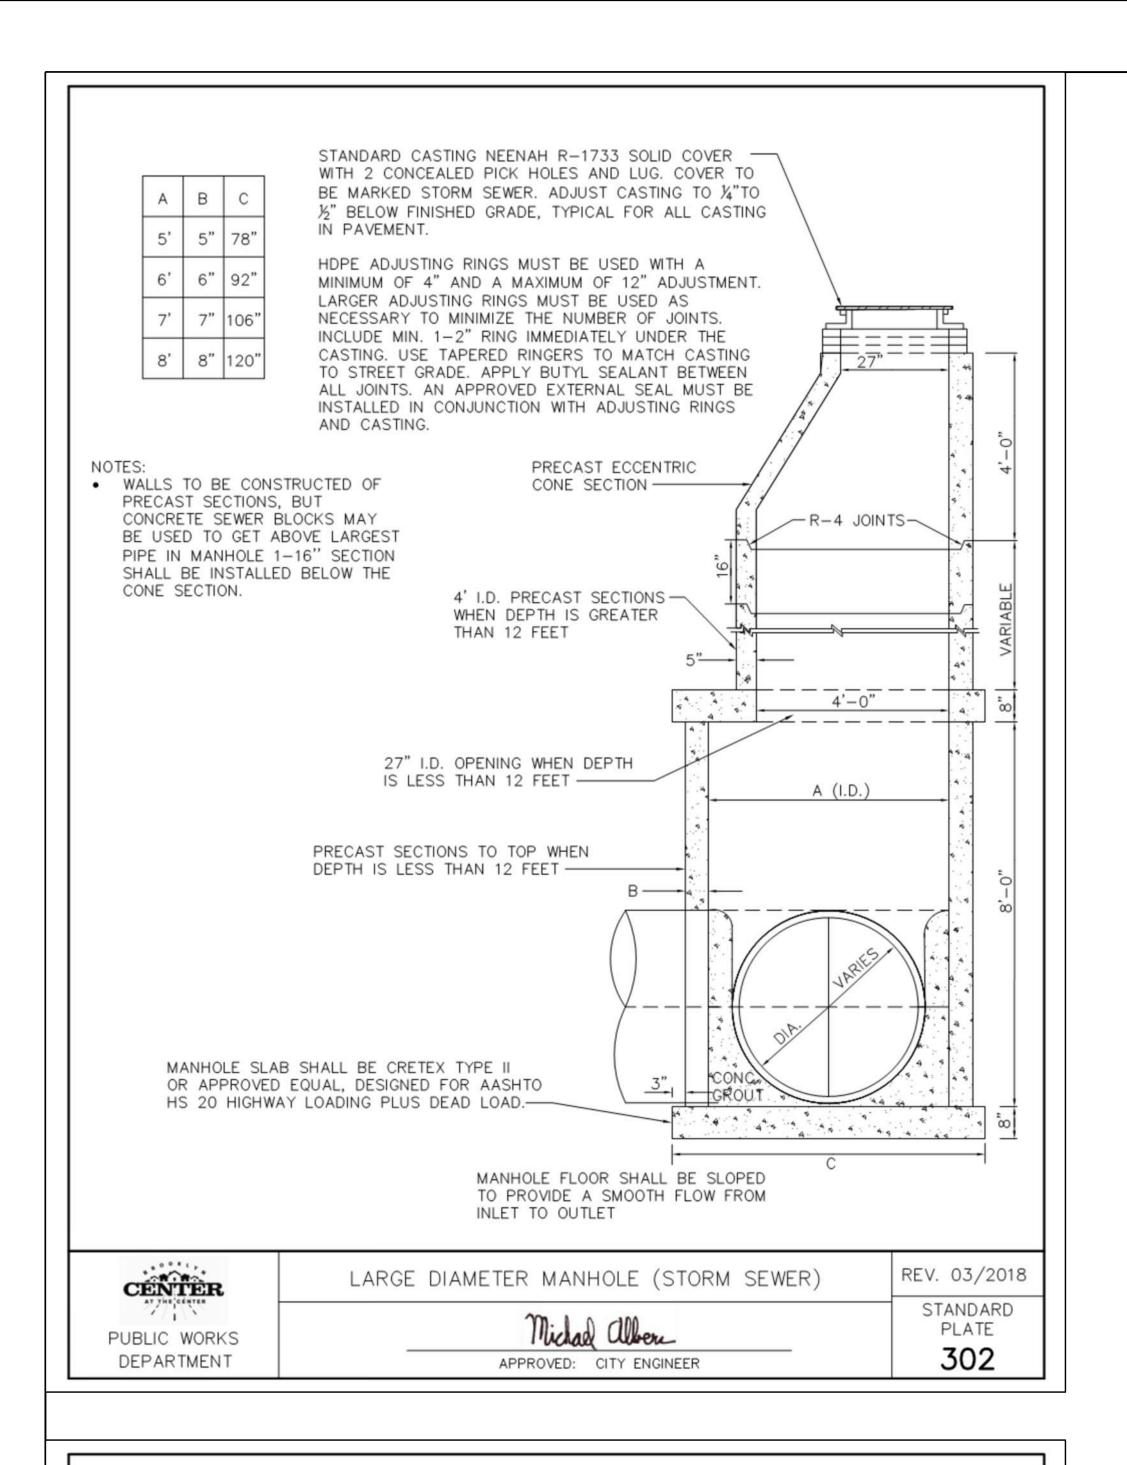

----BACK OF CURB

44 44 44 44

27"

POUR BENCH TO

SPRING LINE

CATCH BASIN MANHOLE

Michael alber

APPROVED: CITY ENGINEER

B-618 CONCRETE -

MINIMUM 3, MAXIMUM 6-2" RINGS. CASTING AND PRECAST CONCRETE RINGS MUST BE SET ON FULL MORTAR BEDS. MORTAR MUST BE

WIPED CLEAN ON THE INSIDE AND

SMOOTH ON THE OUTSIDE OF THE

CRACKED ADJUSTING RINGS WILL BE REJECTED AND ARE NOT

ACCEPTABLE. SHIMS ARE NOT

ALLOWED, NEITHER PLASTIC,

BLOCK NOR WOOD. -

TEMPORARY DRAINAGE -

DURING CONSTRUCTION -PROVIDE TEMPORARY

AGGREGATE DURING

ADEQUATE DRAINAGE. PRIOR TO PAVING THE

COMPLETE CONCRETE

COLLAR.

BASE COURSE, REMOVED PIPE AND AGGREGATE, GROUT HOLE AND

 FOR SHALLOW DEPTH CATCH BASIN STRUCTURES, USE

MN/DOT STANDARD

PLATE 4024A.

FOR TOP SLAB

PLATE 4020J.

CÉÑTÈR

PUBLIC WORKS

DEPARTMENT

DIMENSIONS, USE

MN/DOT STANDARD

CATCH BASIN FLOOR SHALL BE SLOPED TO PROVIDE A SMOOH FLOW FROM INLET

TO OUTLET ----

DRAIN PIPE AND DRAINAGE

CONSTRUCTION TO ENSURE

CASTING AND RINGS. ANY

CURB & GUTTER

CONCRETE ADJUSTING RINGS,

"x10" REBAR ROD. SEE CURB STANDARD

CATCH BASIN CASTING

WITH DIAGONAL GRATE,

AN APPROVED EXTERNAL SEAL MUST BE

ADJUSTING RINGS, CASTING AND PROVIDE

AND INTEGRAL 6" CONCRETE COLLAR TO BE POURED DURING CURB AND GUTTER

─6" PRECAST REINFORCED

-PRECAST MANHOLE SECTIONS

ALL JOINTS SHALL BE R-4

- BLOCK CONSTRUCTION ONLY UPON WRITTEN APPROVAL OF ENGINEER

CONCRETE BLOCK TO THE TOP OF

THE PIPE. FOR MANHOLES WITH PIPE DIAMETER OVER 24". GROUT

BETWEEN, INSIDE, AND OUTSIDE

OF BLOCKS. USE OPENING IN 4'

-MIN. SLAB THICKNESS: 6" FOR

14' DEPTH. INCREASE 1" FOR

EACH 4' OF DEPTH GREATER

6"X 6" 1% MESH.

THAN 14' AND REINFORCE WITH

REV. 03/2018

STANDARD

PLATE

304

MANHOLE SECTION TO 24"

DIAMETER

B" PRECAST SEGMENTAL

CONCRETE SLAB

INSTALLED IN CONJUNCTION WITH


NEENAH R-3250-A


PLATE NO. 404


-GUTTER LINE

OR EQUAL

INSTALLATION

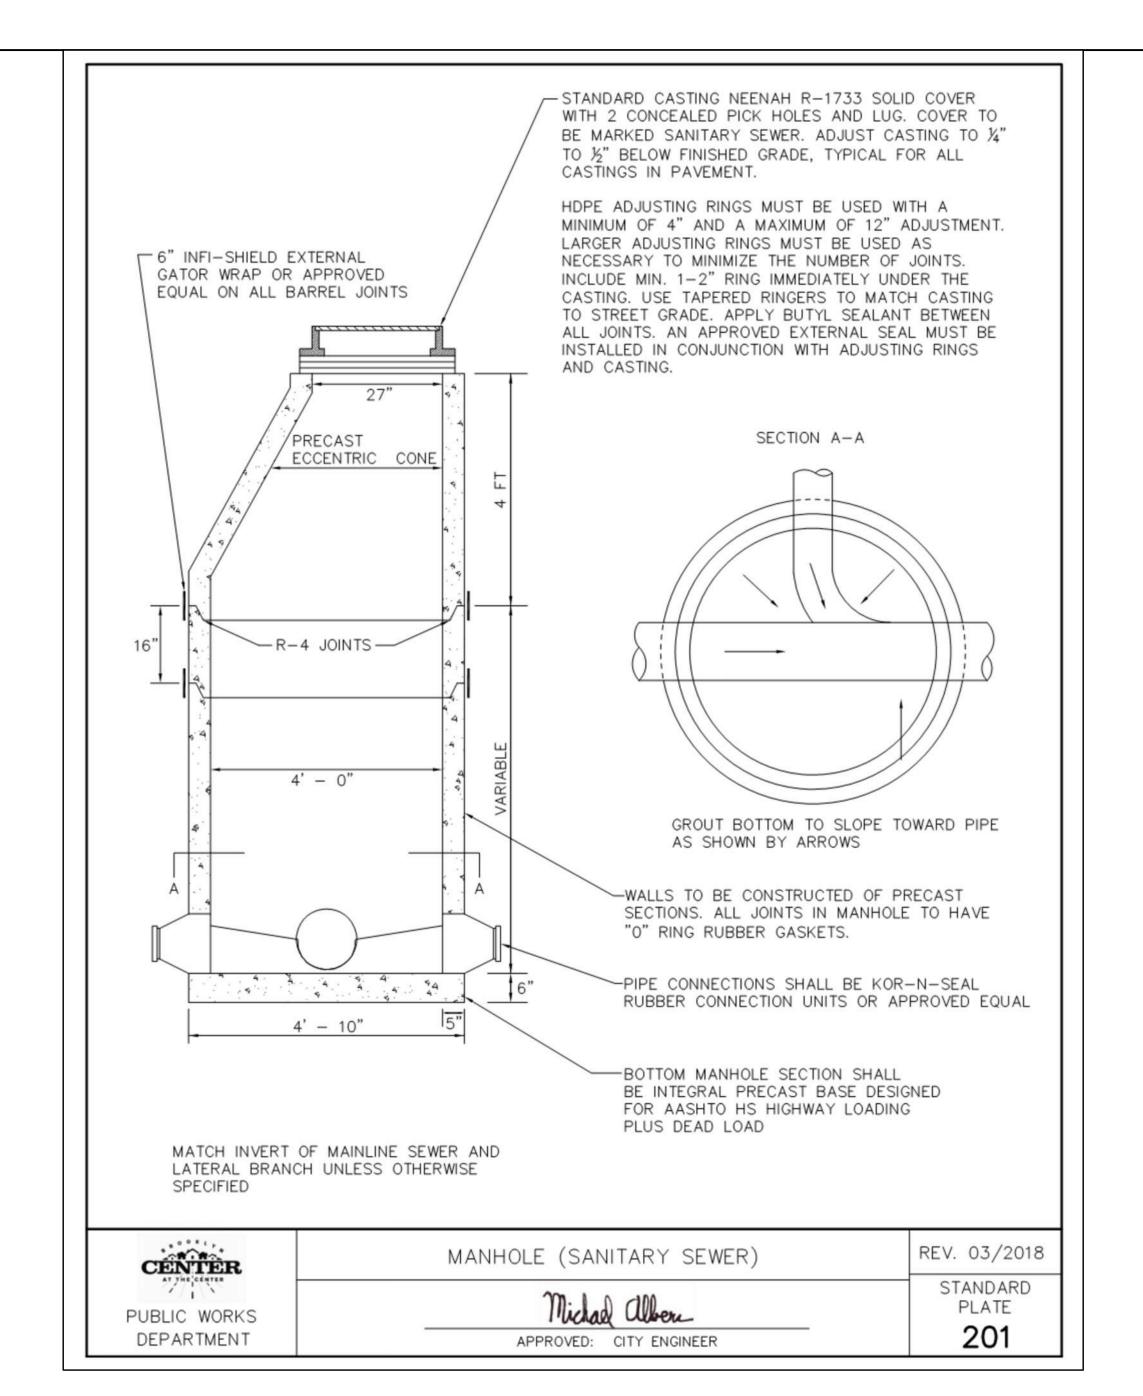

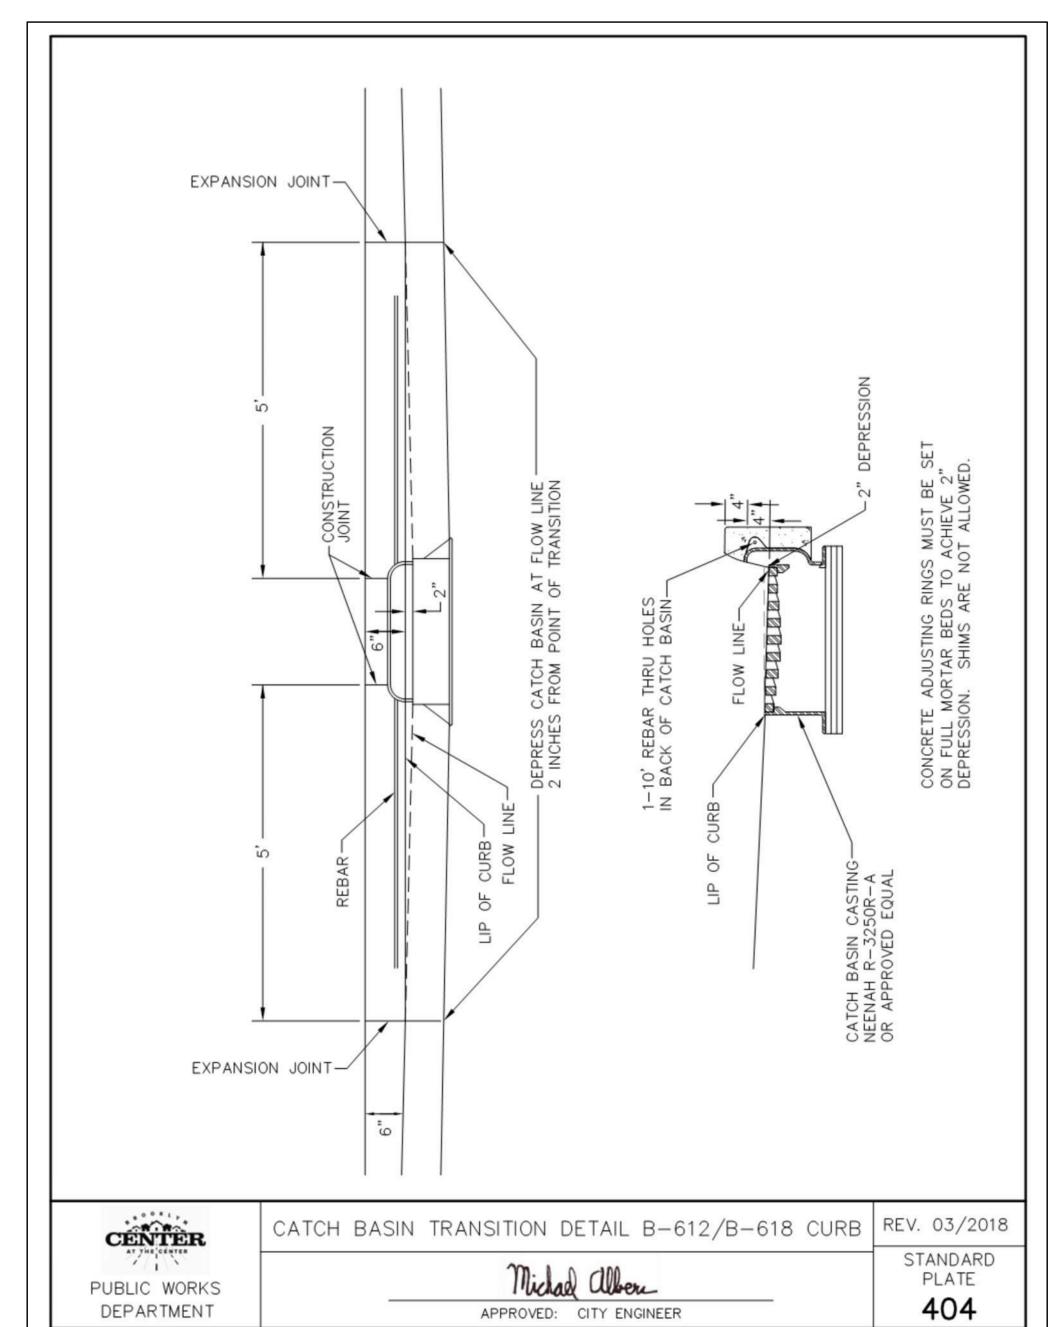

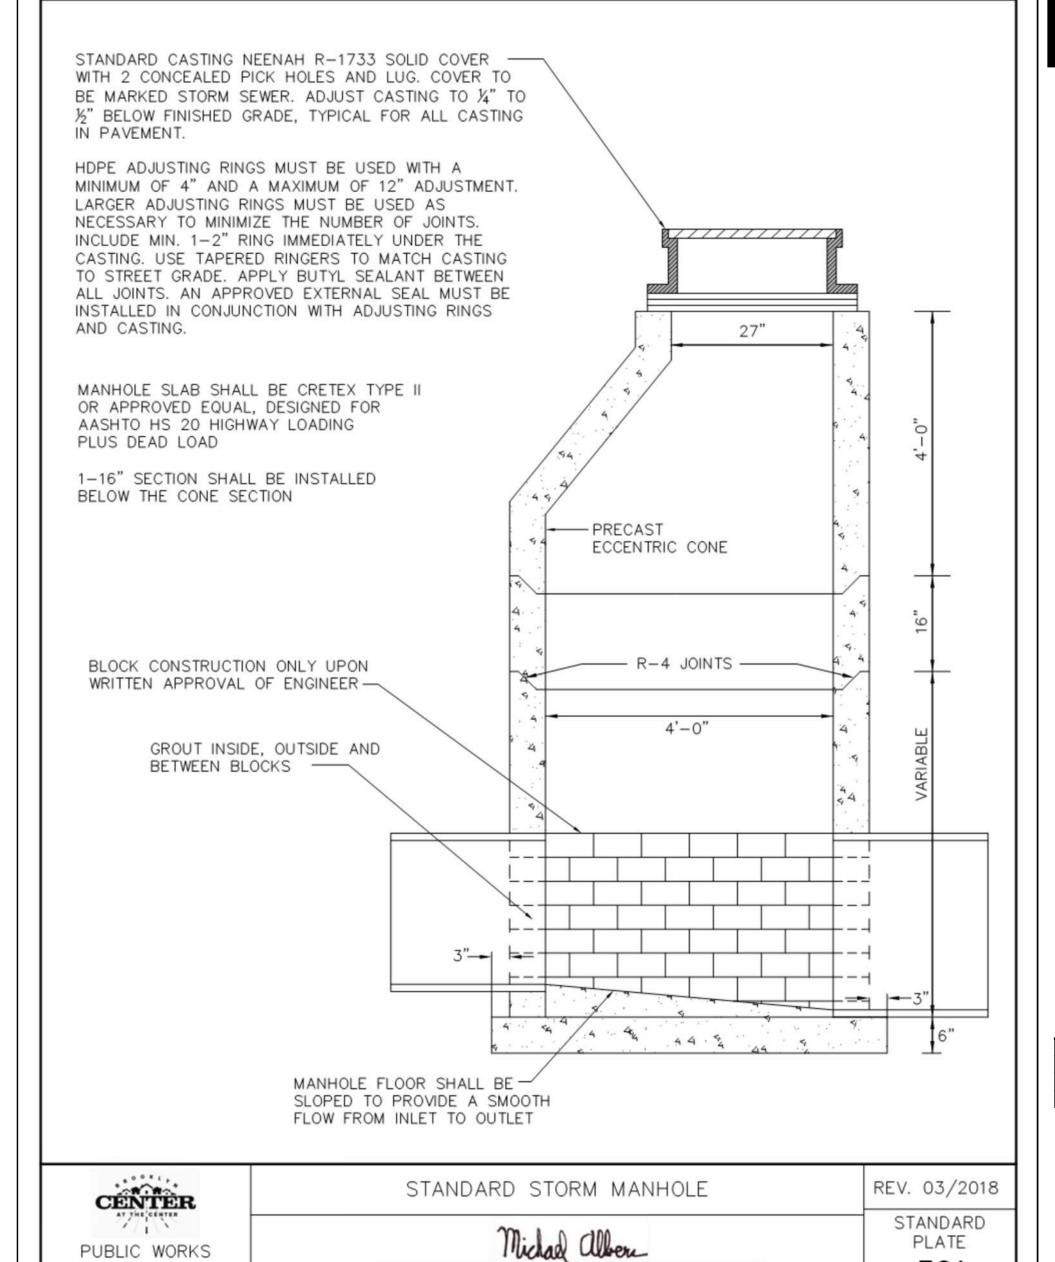

APPROVED: CITY ENGINEER

PUBLIC WORKS

DEPARTMENT



Architecture Interior Design Landscape Architecture Engineering

222 North Second Street Long & Kees Bldg Suite 101 Minneapolis, MN 612.339.3752

www.bkvgroup.com

CONSULTANTS PIERCE PINI & 9298 CENTRAL AVENUE NE. SUITE 312 BLAINE, MN 55434

TEL 763.537.1311

PROJECT TITLE

PLATE

301

BROOKLYN CENTER -ALATUS -MULTIFAMILY HOUSING 1

05/10/2022 LAND USE APPLICATION 06/14/2022 LAND USE APPLICATION 3 06/22/2022 REVISION


CERTIFICATION

CHECKED BY COMMISSION NUMBER SHEET TITLE ALATUS -**MULTIFAMILY** HOUSING 1 - CITY **DETAILS**

SHEET NUMBER





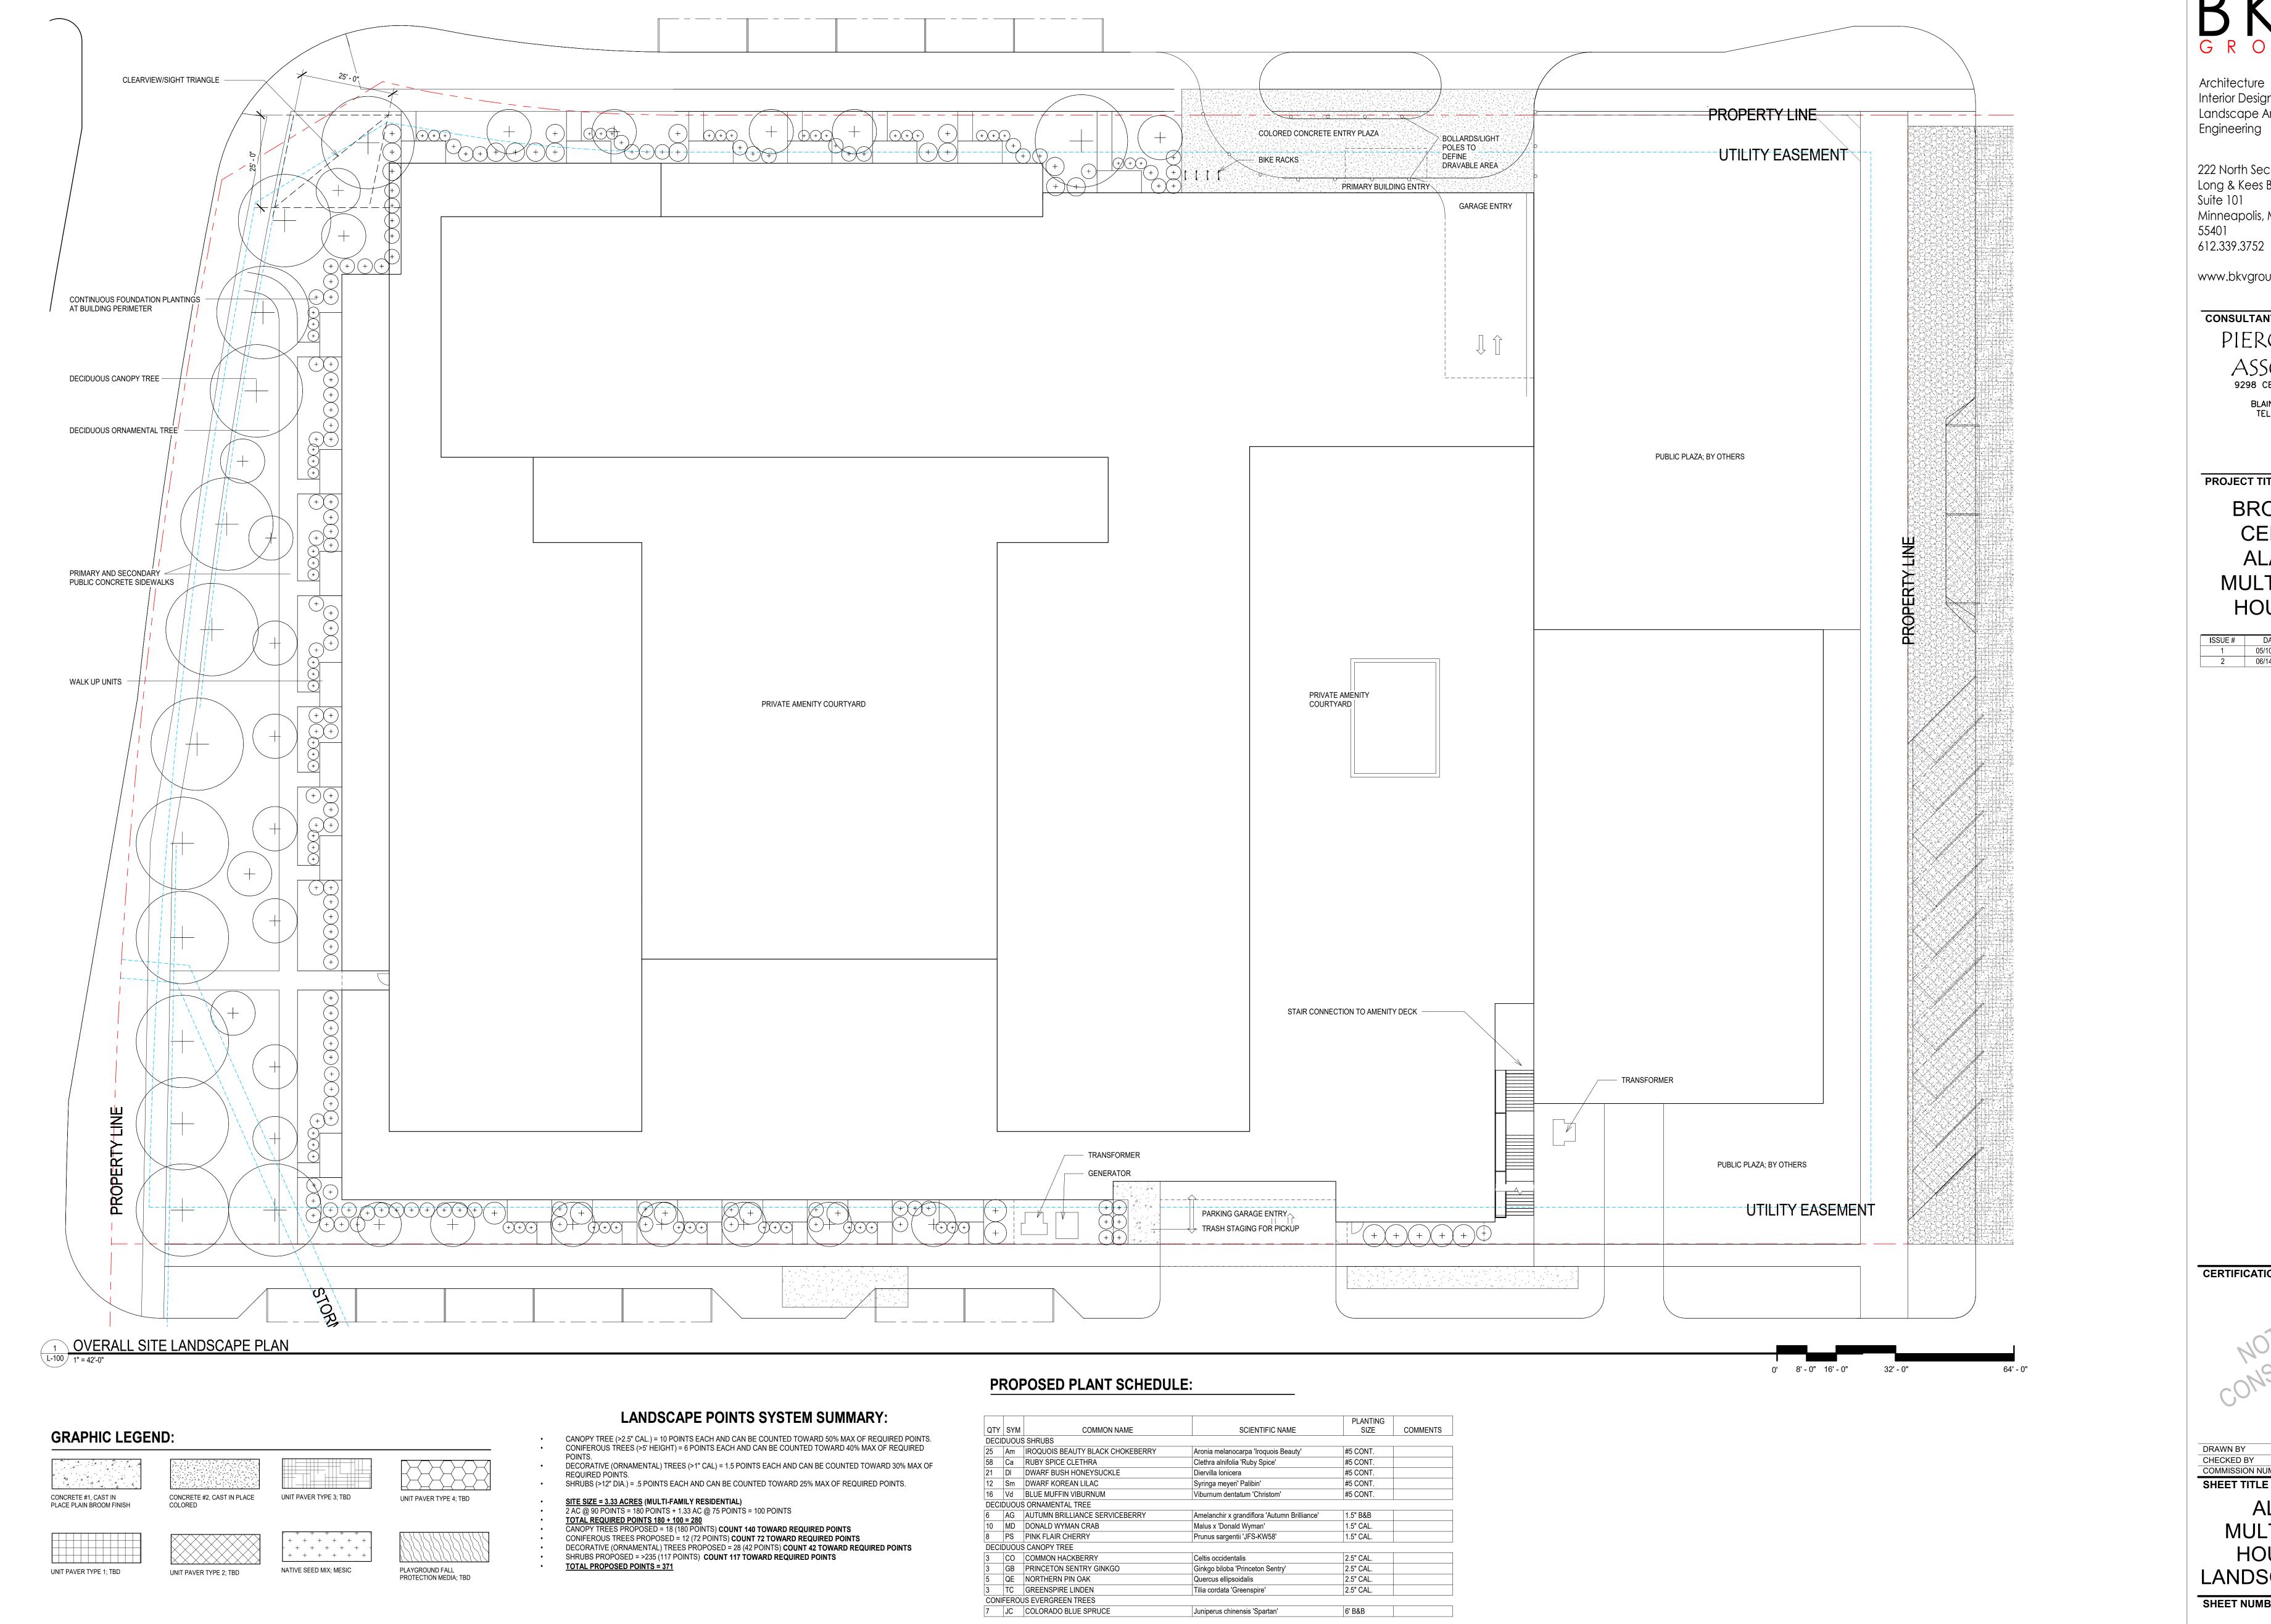

39 Hk KALM AMES HYPERICUM

25 Ss SEM FALSE SPIREA

#2 CONT.

#2 CONT.

Hypericum kalmianum 'Ames'

Sorbaria sorbifolia 'Sem'(PP16,336)

Architecture Interior Design Landscape Architecture Engineering

222 North Second Street Long & Kees Bldg Suite 101 Minneapolis, MN

www.bkvgroup.com

CONSULTANTS PIERCE PINI & 9298 CENTRAL AVENUE NE, SUITE 312 BLAINE, MN 55434 TEL 763.537.1311

PROJECT TITLE

BROOKLYN CENTER -ALATUS -MULTIFAMILY HOUSING 1

ISSUE # DATE DESCRIPTION
1 05/10/2022 LAND USE APPLICATION 2 06/14/2022 LAND USE APPLICATION

CERTIFICATION


DRAWN BY CHECKED BY COMMISSION NUMBER 2344.03 SHEET TITLE

> ALATUS MULTIFAMILY HOUSING 1 LANDSCAPE PLAN

SHEET NUMBER

TRUE NORTH

© 2019 BKV Group

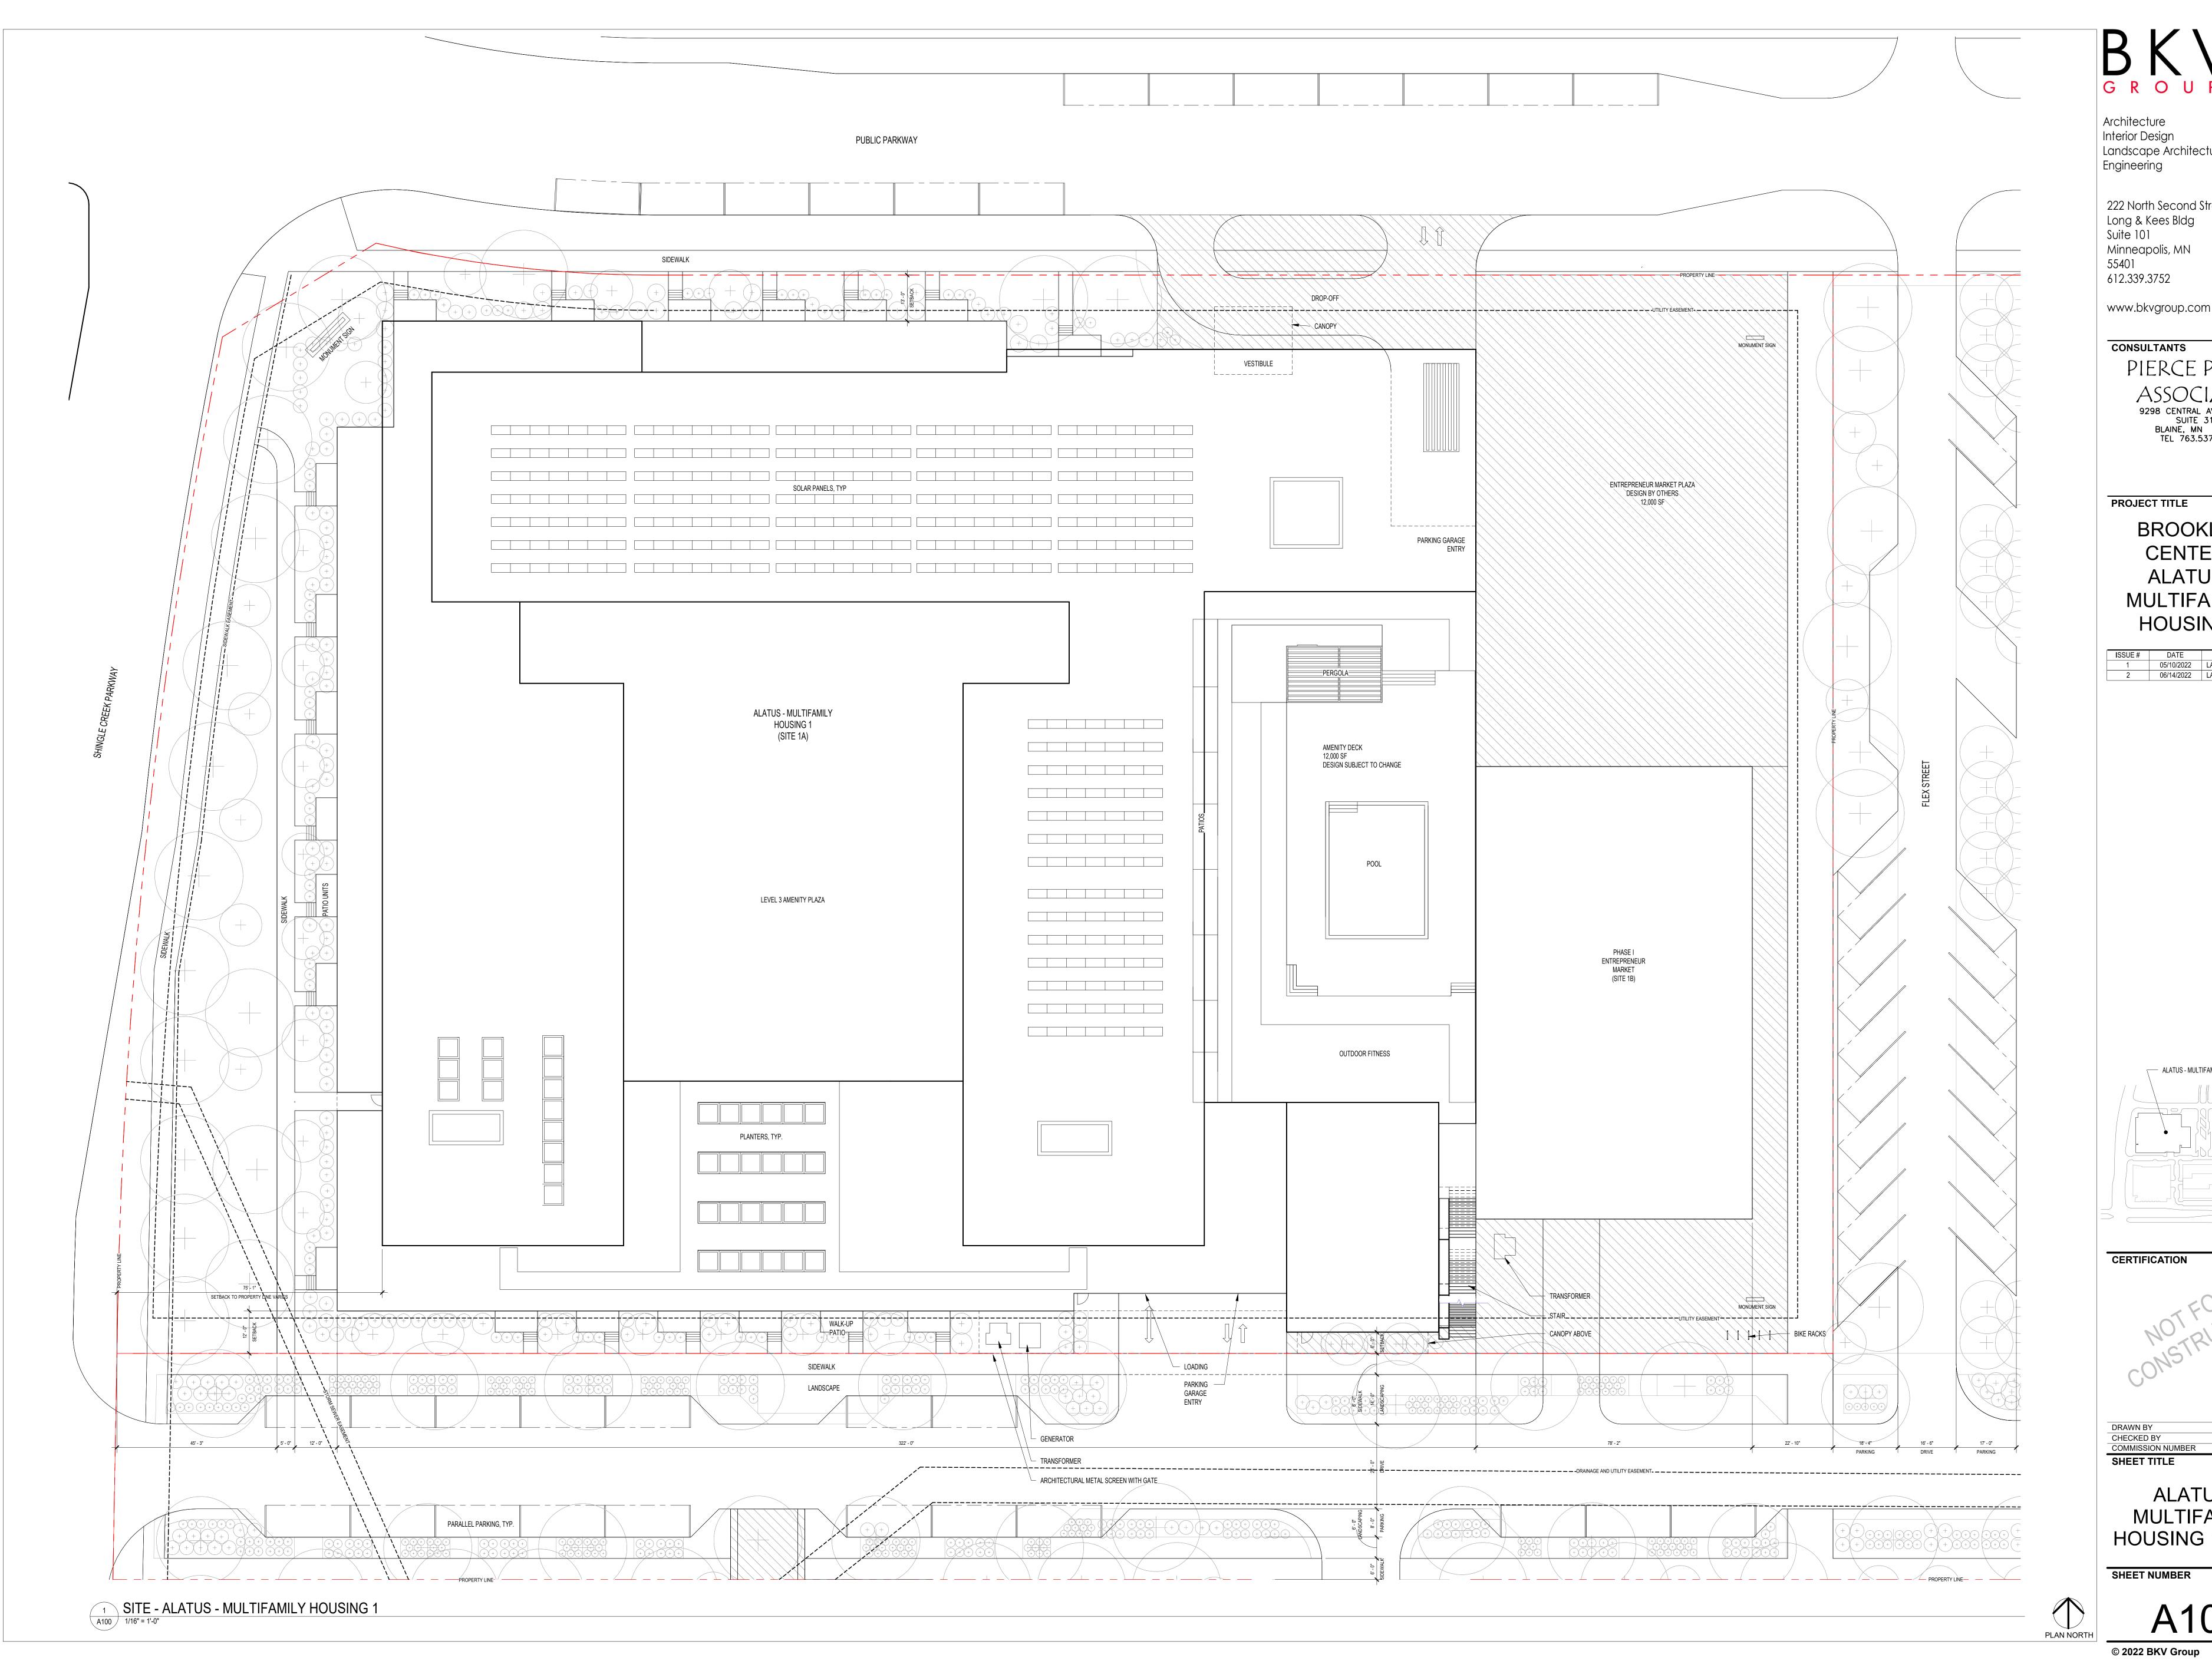

Interior Design Landscape Architecture

222 North Second Street Long & Kees Bldg Minneapolis, MN

PIERCE PINI & **ASSOCIATES** 9298 CENTRAL AVENUE NE, SUITE 312 BLAINE, MN 55434 TEL 763.537.1311

BROOKLYN CENTER -ALATUS -MULTIFAMILY HOUSING 1

ISSUE # DATE DESCRIPTION
1 05/10/2022 LAND USE APPLICATION 2 06/14/2022 LAND USE APPLICATION

- ALATUS - MULTIFAMILY HOUSING 1

CHECKED BY COMMISSION NUMBER SHEET TITLE

ALATUS -MULTIFAMILY

SHEET NUMBER



Architecture Interior Design Landscape Architecture Engineering

222 North Second Street Long & Kees Bldg Suite 101 Minneapolis, MN

www.bkvgroup.com

CONSULTANTS

PIERCE PINI & ASSOCIATES 9298 CENTRAL AVENUE NE, SUITE 312 BLAINE, MN 55434 TEL 763.537.1311

PROJECT TITLE

BROOKLYN CENTER -ALATUS -MULTIFAMILY HOUSING 1

ISSUE # DATE DESCRIPTION

1 05/10/2022 LAND USE APPLICATION

2 06/14/2022 LAND USE APPLICATION

DRAWN BY
CHECKED BY
COMMISSION NUMBER

2344.03 SHEET TITLE

ALATUS -MULTIFAMILY HOUSING 1 -

LEVEL 1

Landscape Architecture

Engineering

222 North Second Street Long & Kees Bldg Suite 101 Minneapolis, MN 55401

www.bkvgroup.com

612.339.3752

CONSULTANTS PIERCE PINI & ASSOCIATES
9298 CENTRAL AVENUE NE,
SUITE 312
BLAINE, MN 55434
TEL 763.537.1311

PROJECT TITLE

BROOKLYN CENTER -ALATUS -MULTIFAMILY HOUSING 1

ISSUE # DATE DESCRIPTION

1 05/10/2022 LAND USE APPLICATION


2 06/14/2022 LAND USE APPLICATION

SHEET TITLE

ALATUS -MULTIFAMILY HOUSING 1 -LEVEL 1.5

SHEET NUMBER

© 2022 BKV Group

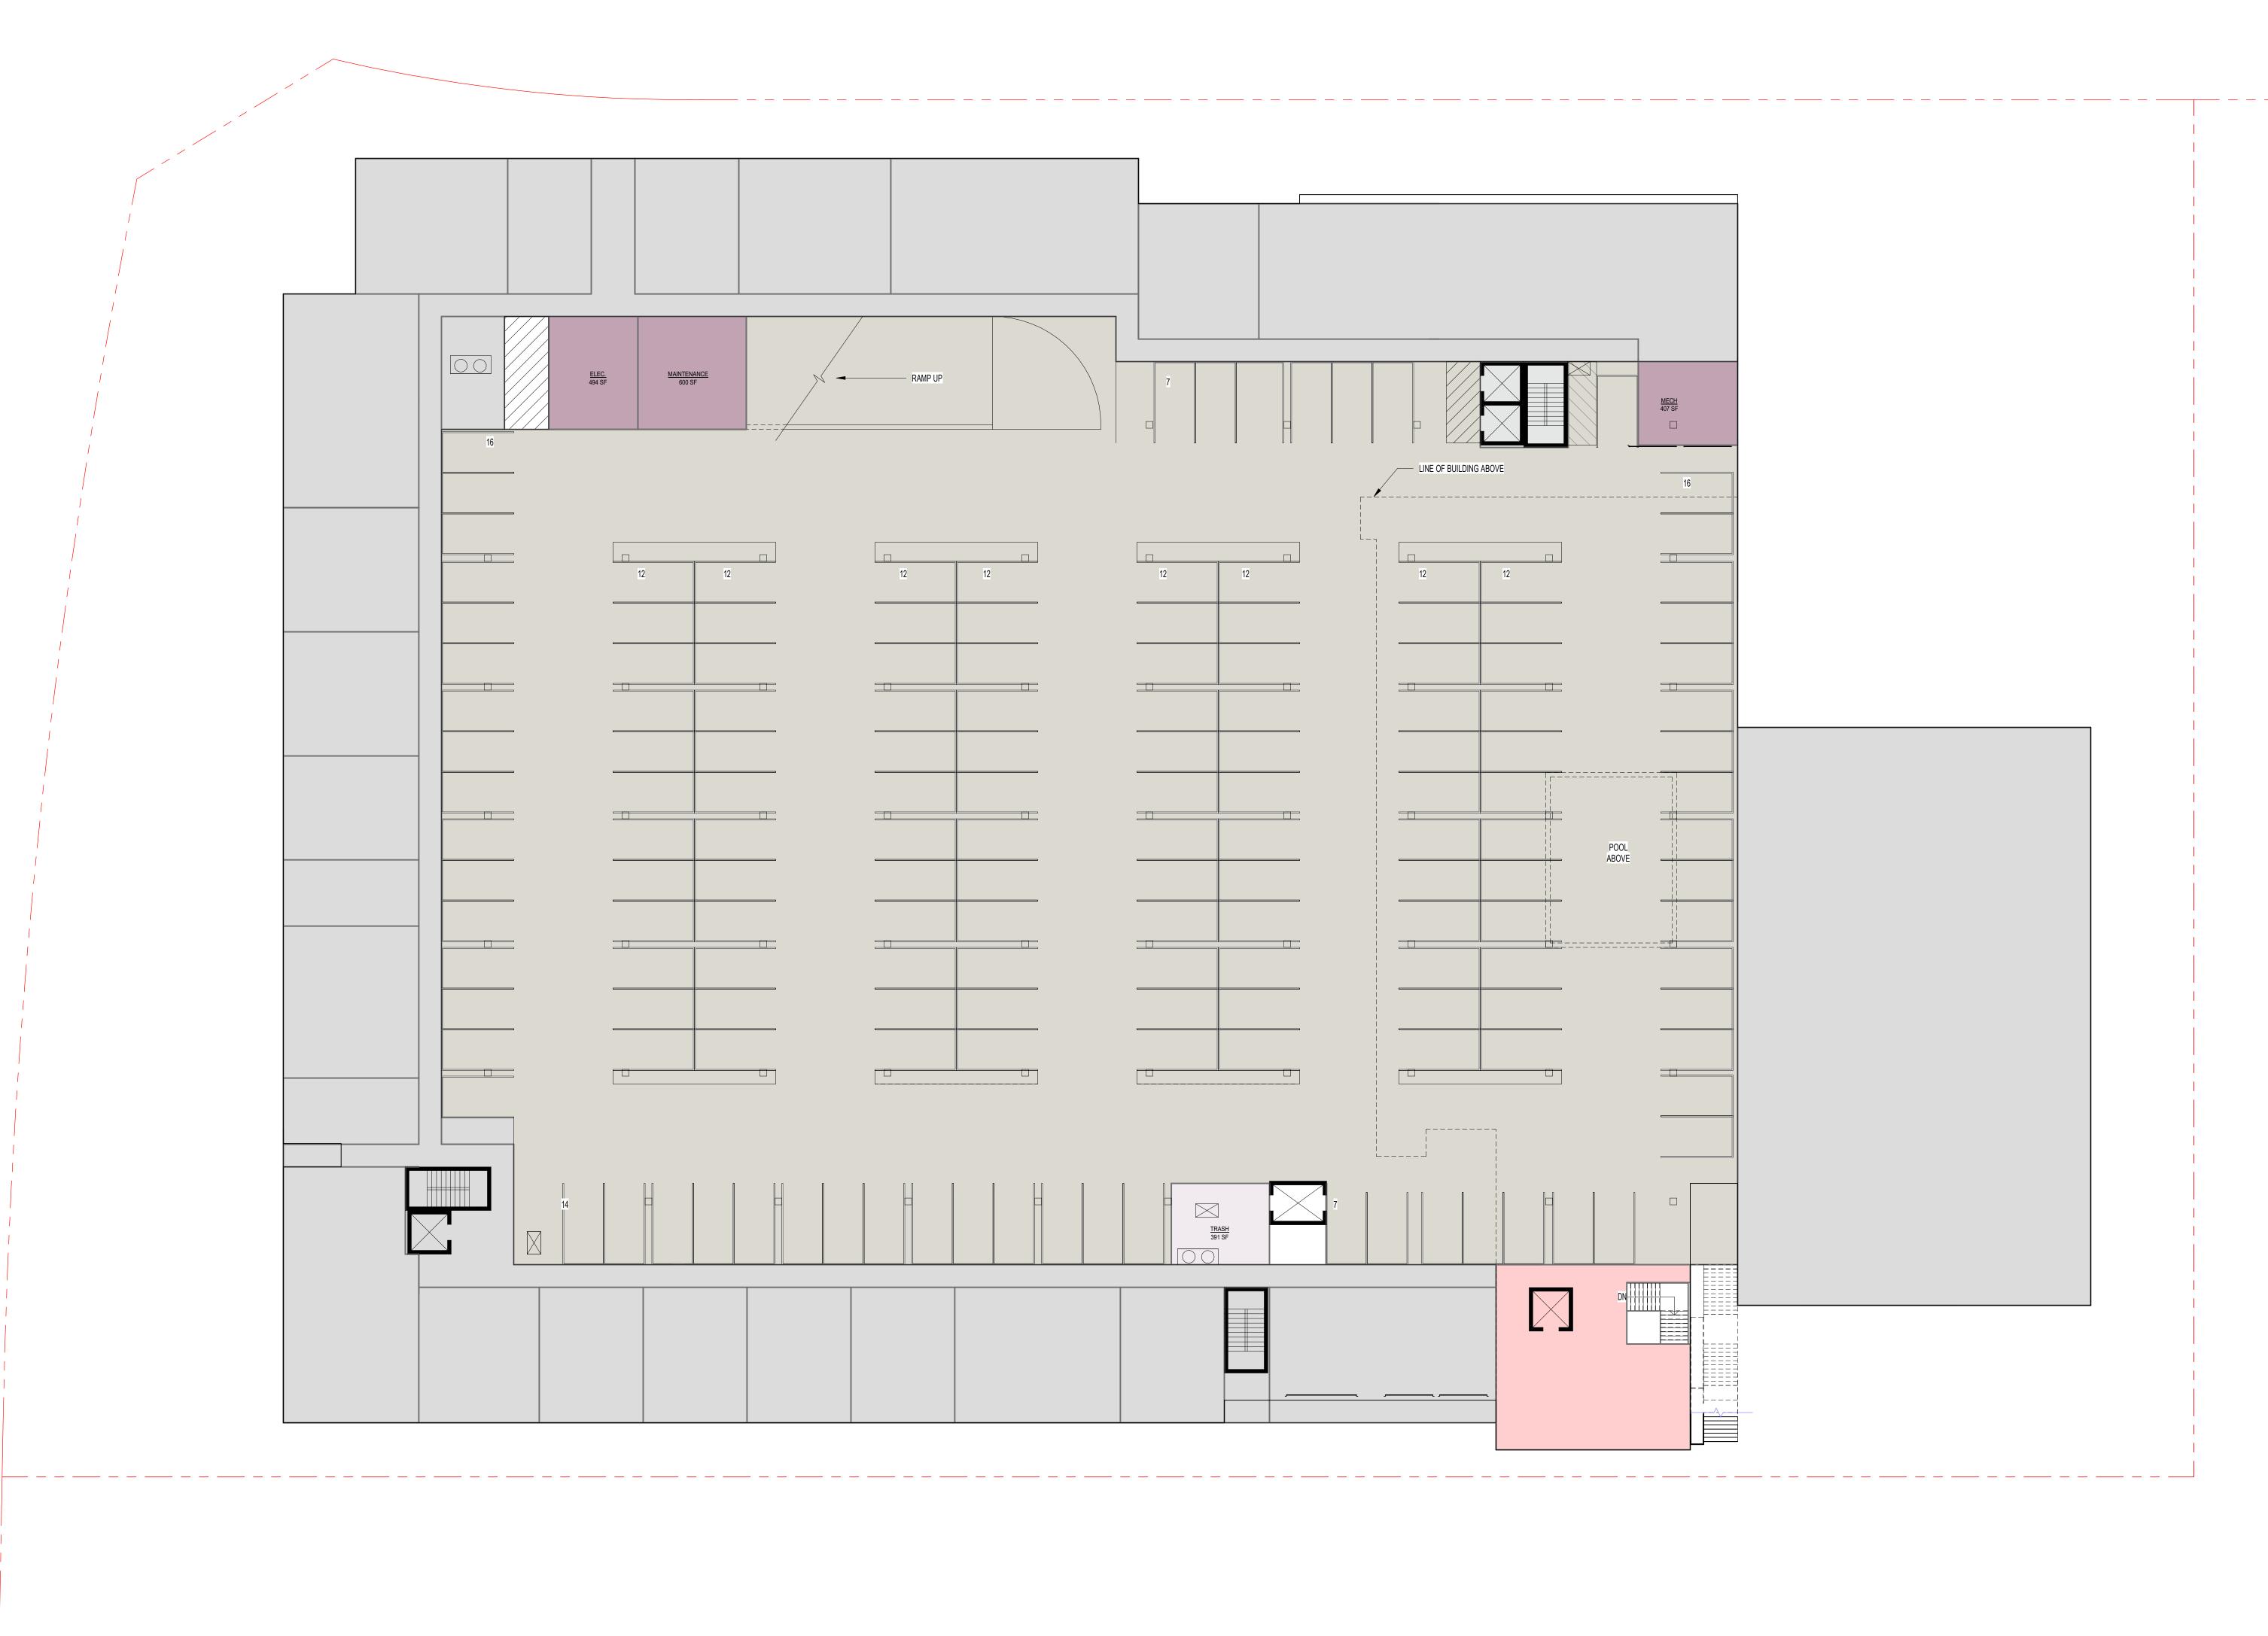

LEVEL 1.5 - ALATUS - MULTIFAMILY HOUSING 1

CALATUS - MULTIFAMILY HOUSING 1

1 LEVEL 2 - ALATUS - MULTIFAMILY HOUSING 1
A102 1/16" = 1'-0"



Architecture Interior Design Landscape Architecture Engineering

222 North Second Street Long & Kees Bldg Suite 101 Minneapolis, MN 612.339.3752

www.bkvgroup.com

CONSULTANTS PIERCE PINI &

ASSOCIATES
9298 CENTRAL AVENUE NE,
SUITE 312
BLAINE, MN 55434
TEL 763.537.1311

PROJECT TITLE

BROOKLYN CENTER -ALATUS -MULTIFAMILY HOUSING 1

ISSUE # DATE DESCRIPTION

1 05/10/2022 LAND USE APPLICATION

2 06/14/2022 LAND USE APPLICATION

SHEET TITLE

ALATUS -MULTIFAMILY HOUSING 1 -LEVEL 2

SHEET NUMBER

CONSULTANTS PIERCE PINI & ASSOCIATES
9298 CENTRAL AVENUE NE,
SUITE 312
BLAINE, MN 55434
TEL 763.537.1311

PROJECT TITLE

612.339.3752

www.bkvgroup.com

BROOKLYN CENTER -ALATUS -MULTIFAMILY HOUSING 1

ISSUE # DATE DESCRIPTION

1 05/10/2022 LAND USE APPLICATION

2 06/14/2022 LAND USE APPLICATION


SHEET TITLE

ALATUS -MULTIFAMILY HOUSING 1 -LEVEL 3

SHEET NUMBER © 2022 BKV Group



1 LEVEL 3 - ALATUS - MULTIFAMILY HOUSING 1
1/16" = 1'-0"

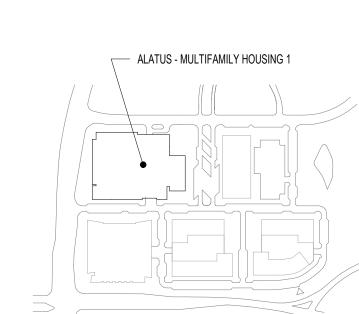

B K V
G R O U P

Architecture
Interior Design
Landscape Architecture
Engineering

222 North Second Street Long & Kees Bldg Suite 101 Minneapolis, MN 55401 612.339.3752

www.bkvgroup.com

PIERCE PINI &

ASSOCIATES

ASSOCIATES

9298 CENTRAL AVENUE NE,
SUITE 312
BLAINE, MN 55434
TEL 763.537.1311

PROJECT TITLE

BROOKLYN
CENTER ALATUS MULTIFAMILY
HOUSING 1

ISSUE # DATE DESCRIPTION

1 05/10/2022 LAND USE APPLICATION

2 06/14/2022 LAND USE APPLICATION

CERTIFICATION

CONSTRUCTION

DRAWN BY Author
CHECKED BY Checker
COMMISSION NUMBER 2344.03
SHEET TITLE


ALATUS -MULTIFAMILY HOUSING 1 -LEVEL 4

SHEET NUMBER

A104

I AN NORTH

1 LEVEL 4 - ALATUS - MULTIFAMILY HOUSING 1
1/16" = 1'-0"

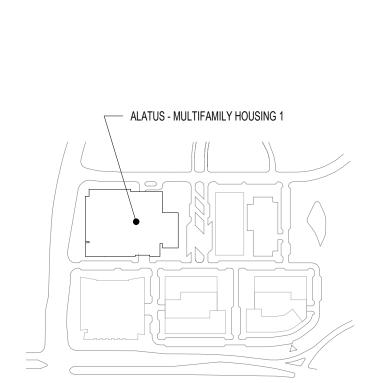

BKV

Architecture
Interior Design
Landscape Architecture
Engineering

222 North Second Street Long & Kees Bldg Suite 101 Minneapolis, MN 55401 612.339.3752

www.bkvgroup.com

CONSULTANTS

PIERCE PINI &

ASSOCIATES

9298 CENTRAL AVENUE NE,
SUITE 312
BLAINE, MN 55434
TEL 763.537.1311

PROJECT TITLE

BROOKLYN
CENTER ALATUS MULTIFAMILY
HOUSING 1

ISSUE # DATE DESCRIPTION

1 05/10/2022 LAND USE APPLICATION

2 06/14/2022 LAND USE APPLICATION

CERTIFICATION

CONSTRUCTION

DRAWN BY Auth
CHECKED BY Che
COMMISSION NUMBER 234
SHEET TITLE

ALATUS -MULTIFAMILY HOUSING 1 -LEVEL 5

SHEET NUMBER

A105

© 2022 BKV Group

1 LEVEL 5 - ALATUS - MULTIFAMILY HOUSING 1

CONSULTANTS

www.bkvgroup.com

PIERCE PINI & ASSOCIATES
9298 CENTRAL AVENUE NE,
SUITE 312
BLAINE, MN 55434
TEL 763.537.1311

PROJECT TITLE

BROOKLYN CENTER -ALATUS -MULTIFAMILY HOUSING 1

ISSUE # DATE DESCRIPTION

1 05/10/2022 LAND USE APPLICATION


2 06/14/2022 LAND USE APPLICATION

SHEET TITLE

ALATUS -MULTIFAMILY HOUSING 1 -LEVEL 6

SHEET NUMBER © 2022 BKV Group



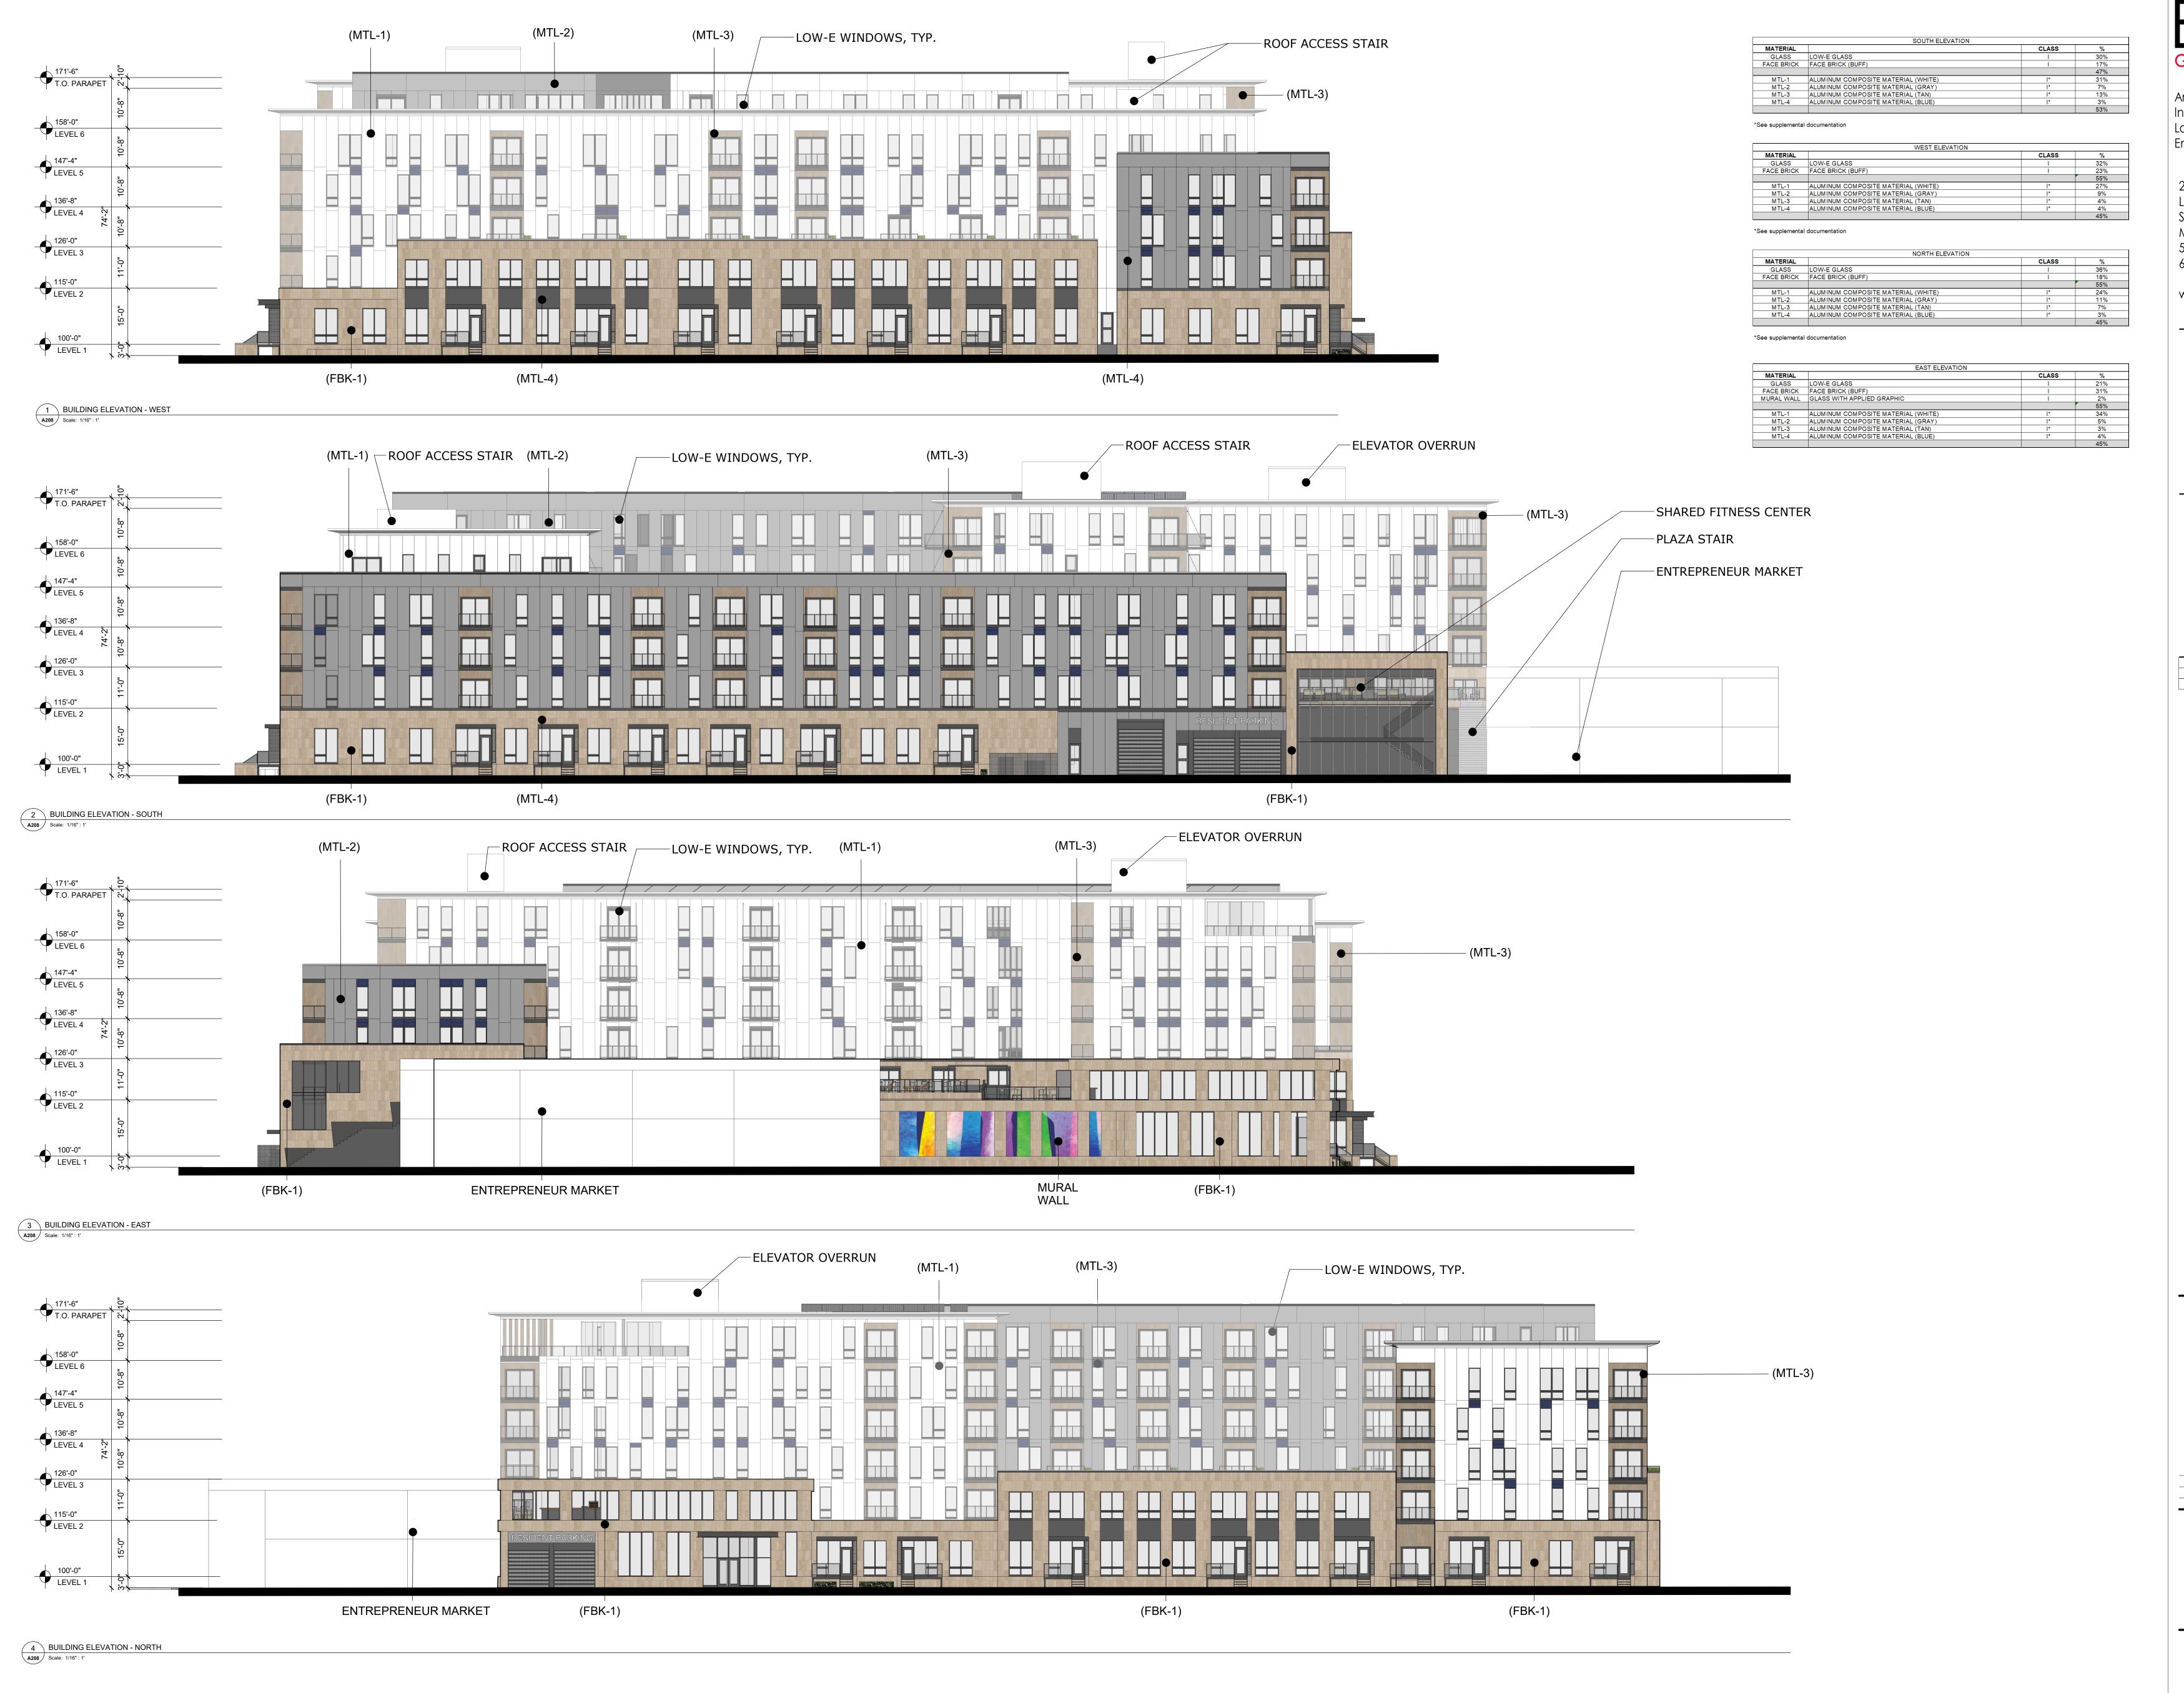

G R O U

Architecture Interior Design Landscape Architecture Engineering

222 North Second Street Long & Kees Bldg Suite 101 Minneapolis, MN 55401 612.339.3752

www.bkvgroup.com

CONSULTANTS PIERCE PINI & 9298 CENTRAL AVENUE NE, SUITE 312 BLAINE, MN 55434 TEL 763.537.1311

PROJECT TITLE

BROOKLYN CENTER -ALATUS -MULTIFAMILY HOUSING 1

1 05/10/2022 LAND USE APPLICATION 2 06/14/2022 LAND USE APPLICATION

CERTIFICATION

DRAWN BY CHECKED BY
COMMISSION NUMBER SHEET TITLE ALATUS -MULTIFAMILY HOUSING 1 -**EXTERIOR** ELEVATIONS SHEET NUMBER

A107

Architecture
Interior Design
Landscape Architecture
Engineering

222 North Second Street Long & Kees Bldg Suite 101 Minneapolis, MN 55401 612.339.3752

www.bkvgroup.com

CONSULTANTS

PIERCE PINI &

ASSOCIATES

9298 CENTRAL AVENUE NE,
SUITE 312
BLAINE, MN 55434
TEL 763.537.1311

PROJECT TITLE

BROOKLYN CENTER -ALATUS -MULTIFAMILY HOUSING 1

ISSUE # DATE DESCRIPTION

1 05/10/2022 LAND USE APPLICATION

2 06/14/2022 LAND USE APPLICATION

CERTIFICATION

CONSTRUCTION

CHECKED BY
CHECKED BY
COMMISSION NUMBER
COMMISSI

A108







Architecture Interior Design Landscape Architecture Engineering

222 North Second Street Long & Kees Bldg Suite 101 Minneapolis, MN 55401 612.339.3752

www.bkvgroup.com

CONSULTANTS PIERCE PINI &

ASSOCIATES
9298 CENTRAL AVENUE NE,
SUITE 312
BLAINE, MN 55434
TEL 763.537.1311

PROJECT TITLE

BROOKLYN CENTER -ALATUS -MULTIFAMILY HOUSING 1

ISSUE # DATE DESCRIPTION

1 05/10/2022 LAND USE APPLICATION

2 06/14/2022 LAND USE APPLICATION





DRAWN BY
CHECKED BY
COMMISSION NUMBER

SHEET TITLE

ALATUS -MULTIFAMILY HOUSING 1 -RENDERINGS

SHEET NUMBER

A109